Pentavia, Mill Hill

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London NW7 2ET Daylight, Sunlight & Overshadowing Date: 22/03/19

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1.0 INTRODUCTION

Delva Patman Redler LLP have been instructed by Meadow Residential to assess the impact of the proposed development on the site known as Pentavia Retail Park, Watford Way, for daylight, sunlight and overshadowing to neighbouring residential properties.

This study has been carried out in accordance with the recommendations of the Building Research Establishment Report "Site Layout Planning for Daylight & Sunlight 2011" (BRE209).

The template drawings, which are attached, illustrate the results for the daylight, sunlight and overshadowing assessments and identify the drawings used in these studies.

2.0 THE PROPOSAL

The proposed development consists of the redevelopment of site including the demolition of all existing buildings and construction of 844 new Build to Rent Class C3 residential units and 894sqm ancillary Class C3 Build to Rent facilities; 405sqm Class A1 Retail; 326sqm Class A3 and A4 food; and 297sqm Class D1 Community; new pedestrian access off Bunns Lane; open space, landscaping; car parking; and highway/pedestrian improvements.

The 844 dwellings are made up of 123 three bed dwellings, 436 two bed dwellings and 281 one bed and 4 studio dwellings.

3.0 POLICY / GUIDELINES

This study has been carried out in accordance with the recommendations of the Building Research Establishment report "Site Layout Planning for Daylight & Sunlight 2011". This is the recognised standard against which daylight and sunlight should be assessed.

The BRE guide is intended for building designers and their clients, consultants and planning officials. The advice given is not mandatory and the report should not be seen as a part of planning policy. Its aim is to help rather than constrain the designer. Although it gives numerical guidelines, these should be interpreted flexibly because natural lighting is only one of the many factors in site layout design. In certain circumstances, the developer or planning authority may wish to use alternative target values.

Whilst technical analysis can be carried out in accordance with numerical guidelines and reported factually by comparison with those guidelines, the final assessment as to whether affected dwellings are left with acceptable amounts of daylight and sunlight in an inner-city context where the findings are to be interpreted in a flexible manner is a matter of subjective opinion.

4.0 METHODOLOGY

The daylight and sunlight assessments have been undertaken in accordance with the Building Research Establishment (BRE) guidelines "Site Layout Planning for Daylight & Sunlight. A Guide to Good Practice".

The BRE Report advises that daylight levels should be assessed for the main habitable rooms of neighbouring residential properties. Habitable rooms in residential properties are defined as kitchens, living rooms and dining rooms. Bedrooms are less important as they are mainly occupied at night time.



DAYLIGHT

The BRE Guide states that:

"If, for any part of the new development, the angle from the centre of the lowest affected window to the head of the new development is more than 25°, then a more detailed check is needed to find the loss of skylight to the existing buildings."

The BRE guidelines propose several methods for calculating daylight. The two main methods predominantly used are those involving the measurement of the total amount of skylight available (the vertical sky component (VSC)) and its distribution within the building (the No-Sky line or daylight distribution).

The VSC calculation is a general test of potential for daylight to a building, measuring the light available on the outside plane of windows.

The "No-Sky" Line divides those areas of the working plane which can receive direct skylight, from those which cannot. It provides an indication of how good the daylight distribution is within a room.

The third recognised method of assessment for daylight is the Average Daylight Factor (ADF) calculation which assesses the quality and distribution of light within a room served by a window and considers the VSC value, the size and number of the windows and room and the use to which the room is put. ADF assesses actual light distribution within a defined room area whereas the VSC considers potential light. British Standard 8206, Code of Practice for Daylighting recommends ADF values of 1% in bedrooms, 1.5% in living rooms and 2% in kitchens. For other uses, where it is expected that supplementary electric lighting will be used throughout the daytime, such as in offices, the ADF value should be 2%. There is no general requirement within the BRE guidelines to assess ADF values, other than for neighbouring residential buildings.

For the purposes of this report all three methods of assessment have been considered.

SUNLIGHT

The BRE have produced sunlight templates for London, Manchester and Edinburgh indicating the Annual Probable Sunlight Hours (APSH) for these regions. The London template has been selected for this study as the London indicator template is the closest of the three available from BRE in terms of latitude.

Sunlight analysis is undertaken by measuring annual probable sunlight hours (APSH) for the main windows of rooms which face within 90° of due south. The maximum number of annual probable sunlight hours for the London orientation is 1,486 hours. The BRE guidelines propose that the appropriate date for undertaking a sunlight assessment is on 21st March, being the spring equinox. Calculations of both summer and winter availability are made with the winter analysis covering the period from the 21st September to 21st March. For residential accommodation, the main requirement for sunlight is in living rooms and it is regarded as less important in bedrooms and kitchens.

Due to orientation and room use not all windows assessed for daylight qualify for sunlight assessment in accordance with BRE Guidance.

All relevant neighbouring residential buildings within the vicinity of the site have been included as part of these assessments. For both daylight and where relevant sunlight as illustrated on site plan dwg no: 16336/LOC/DS/804 and the window location drawings dwg no's: 16336/LOC/841 - 849 attached in appendix A.



OVERSHADOWING

The BRE advises that amenity spaces such as gardens, parks and children's playgrounds should be considered for overshadowing assessments. It recommends that at least half of the amenity areas considered should receive at least two hours of sunlight on 21st March.

5.0 ASSUMPTIONS MADE

• Access has not been sought into any of the neighbouring properties and we have made reasonable assumptions as to the rooms configurations and layouts of neighbouring properties. Where no information has been available, we have adopted a standard 4m deep room for residential premises where applicable. Where floor plans have been obtained these have been adopted for analysis purposes. Properties where layouts have been obtained include:

Site	Address	Information Obtained
1	Palmerstone Court (Churchill Place)	Floor Plans & Elevations
11	40 Brancaster Drive	Floor Plans
16	10 Brancaster Drive	Floor Plans

- All layouts adopted are subject to confirmation following access.
- Floor levels for the neighbouring properties have been assumed using reasonable assumptions.
- Windows at property numbers 2-48 on dwg no: 16336/LOC/DS/804 have been built in from online photography only.

6.0 SOURCE DATA

The studies have been undertaken by calculating the daylight & sunlight based on the template drawings provided within the BRE Guide. The study was undertaken with plan drawings derived from:

- Existing and surround buildings:
- 3D Z Map Model
- Proposed Scheme: Arney Fender Katsalidis Architects: Dwg No's: 3D model received 13/02/2019 – AFK_A_44032_MH_3D Mill Hill GA_Level 00_Overall Plan – A10-00-01-P1, GA_Level 01_Overall Plan – A10-01-01-P1

7.0 SIGNIFICANCE CRITERIA

The guidance given by BRE has been used as a basis for the criteria to assess the Development's potential effects.

In describing the significance criteria as set out below, it should be noted that they have been developed to protect residential properties, which are the most sensitive receptors.



TABLE 1: BRE DAYLIGHT GUIDANCE USED IN THE ASSESSMENT

Issue	Criteria				
Daylight	A window may be affected if the vertical sky component (VSC) measured at the centre of the window is less than 27% and less than 0.8 times its former value.				
	A room may be adversely affected if a significant area of the room is beyond the No-Sky Line and is less than 0.8 times its former value.				
	A room may be adversely affected if the average daylight factor (ADF) is less than 1% for a bedroom, 1.5% for a living room or 2% for a kitchen.				
	Sunlight will be adversely affected if the centre of the window will:				
Sunlight	 receive less than 25% of annual probable sunlight hours (APSH) or less than 5% APSH during the winter months (21 September to 21 March) and 				
-	 less than 0.8 times its former sunlight hours during either period and 				
	• the reduction in sunlight over the whole year will be greater than 4% APSH.				
Overshadowing	At least half of the amenity areas should receive at least two hours of sunlight on 21 st March.				

8.0 BASELINE CONDITIONS

An analysis of the impact of the existing buildings (the baseline conditions) against which to compare any potential impact arising from the development has been undertaken based on dwg no: 16336/SPT/804 in Appendix A.

The site is currently used as a retail park with the main bulk of the massing situated to the north of the development site, with the southern part used for car parking. The site is bound by the M1 to the west and the A1 to the east, as a result of this, there are limited residential properties and amenity area situated close to the development site.

The findings from the technical assessments can be seen from the results, both in graphical and tabular form, in the Technical Appendices A - D.

An analysis of the existing daylight and sunlight levels enjoyed by the neighbouring residential amenity has been undertaken to provide a baseline against which the impacts arising from the proposed development can be assessed.

9.0 RESULTS – COMPLETED DEVELOPMENT

NEIGHBOURING DAYLIGHT - VSC

The full results of the daylight analysis are presented in Appendix B in tabular form. A summary of the results of the Vertical Sky Component (VSC) analysis on the relevant overlooking windows are presented in the Table 2 below. This identifies where habitable rooms are left with adequate light.

Address	Total Number of Rooms Tested	of Rooms BRE Guidelines		Number of Rooms Experiencing Adverse Impacts						
			20-29.9% reduction (minor adverse impact)	30-39.9% reduction (moderate adverse impact	>40% reduction (substantial adverse impact)					
Palmerstone Court	9	9	0	0	0					
82 Bunns Lane	4	3	1	0	0					
80 Bunns Lane	3	3	0	0	0					



1-33 Grahame Park Way					
	33	33	0	0	0
1-26 Cranwell Court	12	12	0	0	0
18-30 Lancaster Close	42	42	0	0	0
13 Lancaster Close	2	2	0	0	0
10 Brancaster Drive	4	4	0	0	0
12 Brancaster Drive	3	3	0	0	0
14 Brancaster Drive	3	3	0	0	0
16 Brancaster Drive	4	4	0	0	0
6 Briston Mews	1	1	0	0	0
40 Brancaster Drive	1	1	0	0	0
42 Brancaster Drive	1	1	0	0	0
Farmhouse Court, 1-6 Bunns Lane	12	12	0	0	0
Farmhouse Court, 7-12 Bunns Lane	12	12	0	0	0
Farmhouse Court, 13-18 Bunns Lane	12	12	0	0	0
Farmhouse Court, 19-24 Bunns Lane	12	12	0	0	0
76 Bunns Lane	3	3	0	0	0
78 Bunns Lane	3	3	0	0	0
76 Bunns Lane Farmhouse Court, 19-24 Bunns Lane	3	3	0	0	0

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Table 2 shows that 176 (100%) of the 176 rooms assessed will all comfortably remain compliant with the BRE Guidelines in Vertical Sky Component terms.

NEIGHBOURING DAYLIGHT – NO SKY LINE (NSL)

The full results of the daylight analysis are presented in Appendix B in tabular form. A summary of the results of the No Sky Line (NSL) analysis on the relevant overlooking windows are presented in the Table 3 below. This identifies where habitable rooms/windows are left with adequate light.

TABLE 3: NUMBER OF ROOMS EXPERIENCING DAYLIGHT IMPACTS AS A RESULT OF THE DEVELOPMENT (NSL METHOD)

Address	Total Number of Rooms Tested	Rooms Meeting BRE Guidelines For NSL	of Rooms Experiencing	Adverse Impacts	
			20-29.9% reduction (minor adverse impact)	30-39.9% reduction (moderate adverse impact	>40% reduction (substantial adverse impact)
Palmerstone Court	9	9	0	0	0
82 Bunns Lane	4	3	0	1	0
80 Bunns Lane	3	3	0	0	0
78 Bunns Lane	3	3	0	0	0
76 Bunns Lane	3	3	0	0	0
Farmhouse Court, 19-24 Bunns Lane	12	12	0	0	0
Farmhouse Court, 13-18 Bunns Lane	12	12	0	0	0
Farmhouse Court, 7-12 Bunns Lane	12	12	0	0	0
Farmhouse Court, 1-6 Bunns Lane	12	12	0	0	0
42 Brancaster Drive	1	1	0	0	0

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Total	176	167	8	1	0	
1-33 Grahame Park Way	33	33	0	0	0	
1-26 Cranwell Court	12	12	0	0	0	
18-30 Lancaster Close	42	34	8	0	0	
13 Lancaster Close	2	2	0	0	0	
10 Brancaster Drive	4	4	0	0	0	
12 Brancaster Drive	3	3	0	0	0	
14 Brancaster Drive	3	3	0	0	0	
16 Brancaster Drive	4	4	0	0	0	
6 Briston Mews	1	1	0	0	0	
40 Brancaster Drive	1	1	0	0	0	

Table 3 shows that 168 out of the 176 (95.5%) rooms assessed will fully comply with the BRE Guidelines in Daylight Distribution terms.

The rooms which fall below this guideline still retain a proposed figure of over 65% in the proposed situation. This is considered to be minor adverse impacts of the BRE Guidelines and in addition these rooms comfortably comply in both the primary method of the Vertical Sky Component (VSC) and Average Daylight Factor (ADF) methods of assessment.

NEIGHBOURING DAYLIGHT - AVERAGE DAYLIGHT FACTOR (ADF)

The full results of the daylight analysis are presented in Appendix B in tabular form. A summary of the results of the Average Daylight Factor (ADF) analysis on the relevant overlooking windows are presented in the Table 4 below. This identifies where habitable rooms/windows are left with adequate light.

Address	Total Number of Rooms Tested	Rooms Meeting BRE Guidelines For ADF	of Rooms Experiencing	Adverse Impacts	
			20-29.9% reduction (minor adverse impact)	30-39.9% reduction (moderate adverse impact	>40% reduction (substantial adverse impact)
Palmerstone Court	9	9	0	0	0
82 Bunns Lane	4	3	0	1	0
80 Bunns Lane	3	3	0	0	0
78 Bunns Lane	3	3	0	0	0
76 Bunns Lane	3	3	0	0	0
Farmhouse Court, 19-24 Bunns Lane	12	12	0	0	0
Farmhouse Court, 13-18 Bunns Lane	12	12	0	0	0
Farmhouse Court, 7-12 Bunns Lane	12	12	0	0	0
Farmhouse Court, 1-6 Bunns Lane	12	12	0	0	0
42 Brancaster Drive	1	1	0	0	0
40 Brancaster Drive	1	1	0	0	0
6 Briston Mews	1	1	0	0	0
16 Brancaster Drive	4	4	0	0	0

TABLE 4: NUMBER OF ROOMS EXPERIENCING DAYLIGHT IMPACTS AS A RESULT OF THE DEVELOPMENT (ADF METHOD)



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14 Brancaster Drive	3	3	0	0	0	
12 Brancaster Drive	3	3	0	0	0	
10 Brancaster Drive	4	4	0	0	0	
13 Lancaster Close	2	2	0	0	0	
18-30 Lancaster Close	42	34	0	0	0	
1-26 Cranwell Court	12	12	0	0	0	
1-33 Grahame Park Way	33	33	0	0	0	
Total	176	176	0	0	0	

Table 4 shows that all 176 (100%) rooms assessed will fully comply with the BRE Guidelines in ADF terms.

Overall the daylight analysis demonstrates that generally the quality, quantity and distribution of light within the neighbouring rooms will remain adequate for an urban location such as this.

NEIGHBOURING SUNLIGHT – APSH

The full results of the sunlight analysis are presented in Appendix B in tabular form. A summary of the results of the Annual Probable Sunlight Hours (APSH) analysis on the relevant overlooking windows are presented in the Table 5 below. This identifies where habitable rooms are left with adequate light.

TABLE 5: NUMBER OF WINDOWS EXPERIENCING SUNLIGHT IMPACTS AS A RESULT OF THE DEVELOPMENT (APSH METHOD)

Address	Total Number of Windows Tested	Windows Meeting BRE Guidelines for APSH	Number of Windows Experiencing Impacts beyond BRE Guidance			
Palmerstone Court	18	18	0			
82 Bunns Lane	8	8	0			
80 Bunns Lane	7	7	0			
78 Bunns lane	7	7	0			
76 Bunns Lane	7	7	0			
Farmhouse Court, 19-24 Bunns Lane	12	12	0			
Farmhouse Court, 13-18 Bunns Lane	12	12	0			
Farmhouse Court, 7-12 Bunns Lane	12	12	0			
Farmhouse Court, 1-6 Bunns Lane	12	12	0			
14 Brancaster Drive	1	1	0			
12 Brancaster Drive	2	2	0			
Total	98	98	0			

Table 5 shows that all windows considered will comfortably comply with the BRE Guidelines in APSH terms.

Overall the sunlight analysis demonstrates that the quality of sunlight within the neighbouring rooms will remain fully BRE compliant in APSH terms.

INTERNAL DAYLIGHT ADEQUACY (SELF-TEST) - AVERAGE DAYLIGHT FACTOR (ADF)

The proposed development is split into 18 blocks from Blocks A-R inclusive. The ground and first floors of each block have been assessed to illustrate the design compliance of the current proposals

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and can be seen on dwg no's 16336/LOC/850 - 855 in Appendix C. Within each block these levels are the lowest levels of residential accommodation. Above these floor levels, the lighting levels will naturally improve and therefore the analysis within this report can be said to consider the 'worst case scenario' levels within each block only.

It is recognised that there are 204 single aspect north facing units (24.1%). These are situated exclusively within blocks A, C, E, G, J, L, N, Q and R. This is as a result of the constraints and location of the site. Arney Fender Katsalidis Architects have designed each of the units to ensure the outlook for the units main living areas is not over the M1 motorway and utilises the central amenity spaces instead.

The analysis demonstrates that of the 489 rooms assessed at ground and first floors throughout the 18 blocks that 346 rooms (70.8%) will comfortably comply with the BRE guidelines for internal daylight adequacy.

Overall the assessment demonstrates that although there are a small number of infringements which are primarily due to the inherent restrictions placed on the development that the quality, quantity and distribution of light within the proposed rooms will generally remain BRE compliant.

OVERSHADOWING

The BRE Guideline suggest that at least half of the amenity areas should receive at least two hours of sunlight to be considered compliant.

Drawing 16336/SHD/523 - 529 in Appendix D shows the amenity areas within the scheme itself and the central public square hatching the areas which receive at least two hours of sunlight on 21 March. This assessment demonstrates that 68% of all amenity spaces will meet the BRE Guidelines.

10.0 CONCLUSIONS

The site is currently used as a retail park with the main bulk of the massing situated to the north of the development site, with the southern part used for car parking. The site is bound by the M1 to the west and the A1 to the east, as a result of this, there are limited residential properties and amenity area situated close to the development site.

To assess the potential impact of the Development on daylight and sunlight on neighbouring properties a baseline assessment was undertaken. The methods of assessment used were the Vertical Sky Component (VSC), No Sky Line (NSL) and Average Daylight Factor (ADF) for daylight and Annual Probable Sunlight Hours (APSH) for sunlight.

Overall the neighbouring daylight analysis illustrates that despite 9 isolated infringements of daylight in daylight distribution (No Sky Line) analysis, generally the quality, quantity and distribution of light within the neighbouring rooms will remain fully BRE compliant.

The sunlight analysis demonstrates that overall the amount of sunlight received by the neighbouring properties will remain fully BRE compliant.

The internal daylight adequacy analysis of the scheme demonstrates that 70.8% of all rooms within the ground and first floor levels of the 18 blocks will comply with the BRE target values.

The overshadowing results show that the proposed amenity areas will comply with the guidance outlined in the BRE.

Overall, the analysis undertaken demonstrates that given the approach recommended by the BRE guidelines, that the proposed development will have a negligible impact on the residential amenity



adjacent to the development site. The scheme proposals by Arney Fender Katsalidis Architects will generally recognise and observe the intentions of London Borough of Barnet local plan and BRE Guidance 209 in daylight, sunlight and overshadowing terms.

Delva Patman Redler LLP




APPENDIX A

LOCATION DRAWINGS


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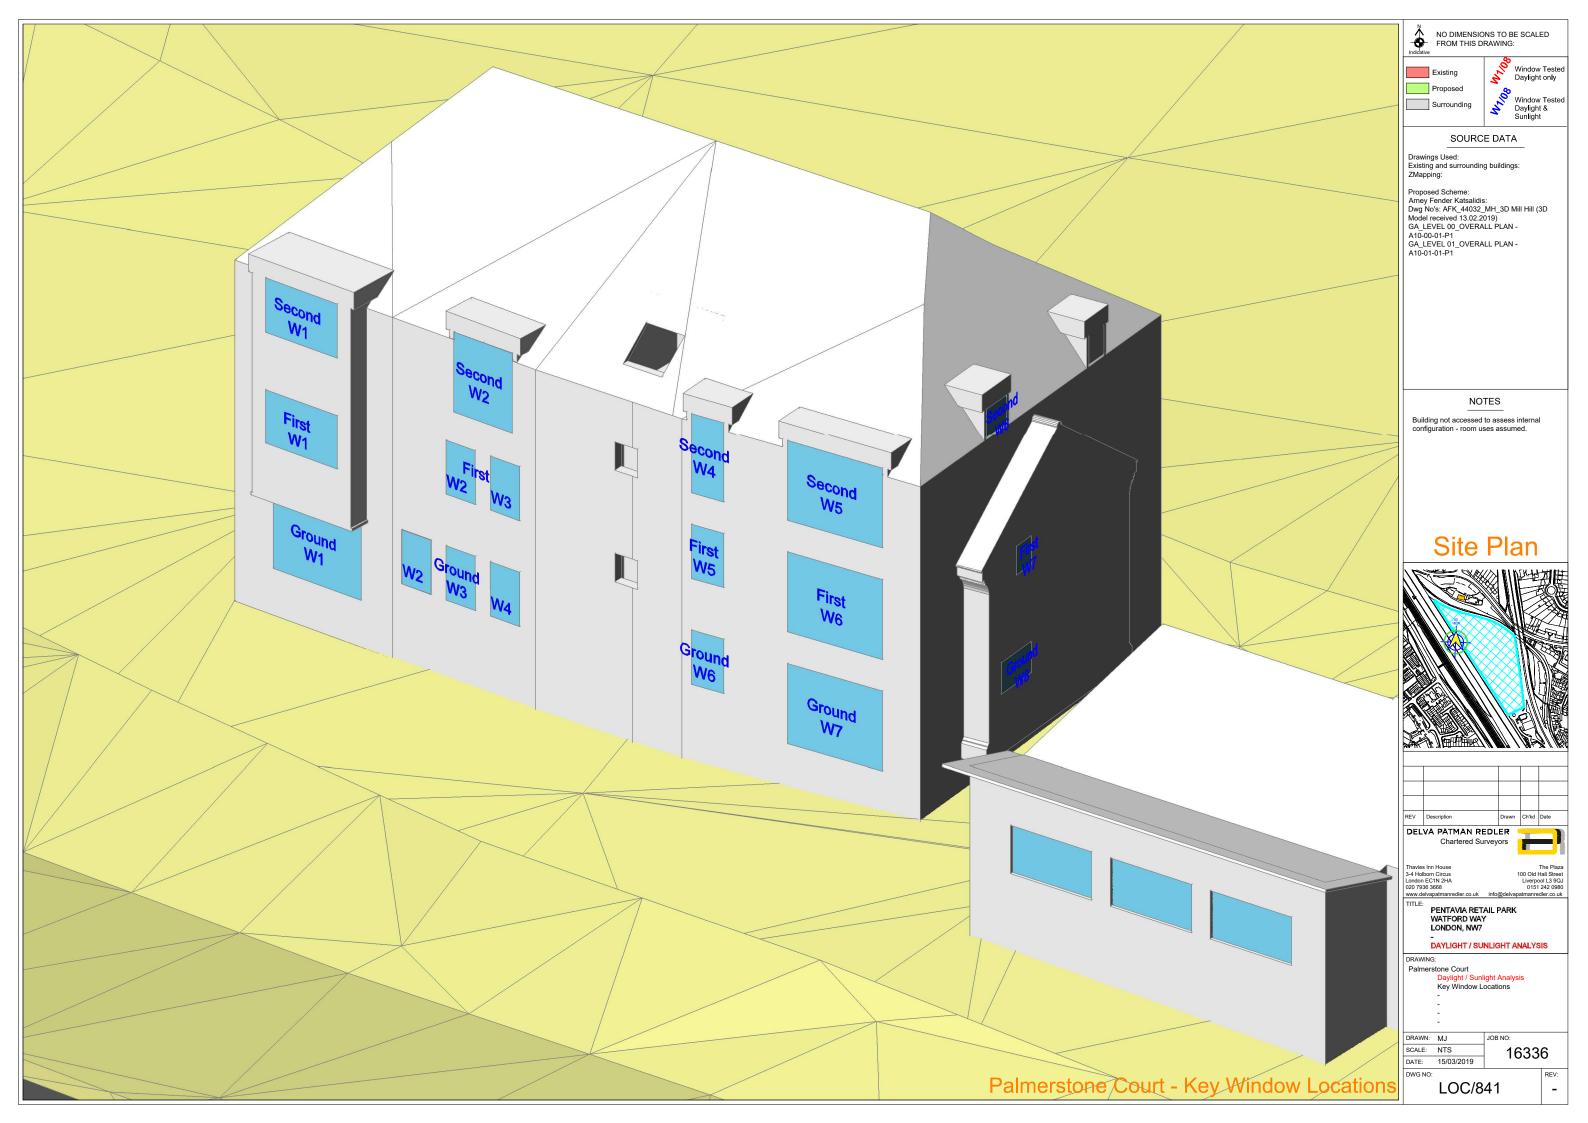
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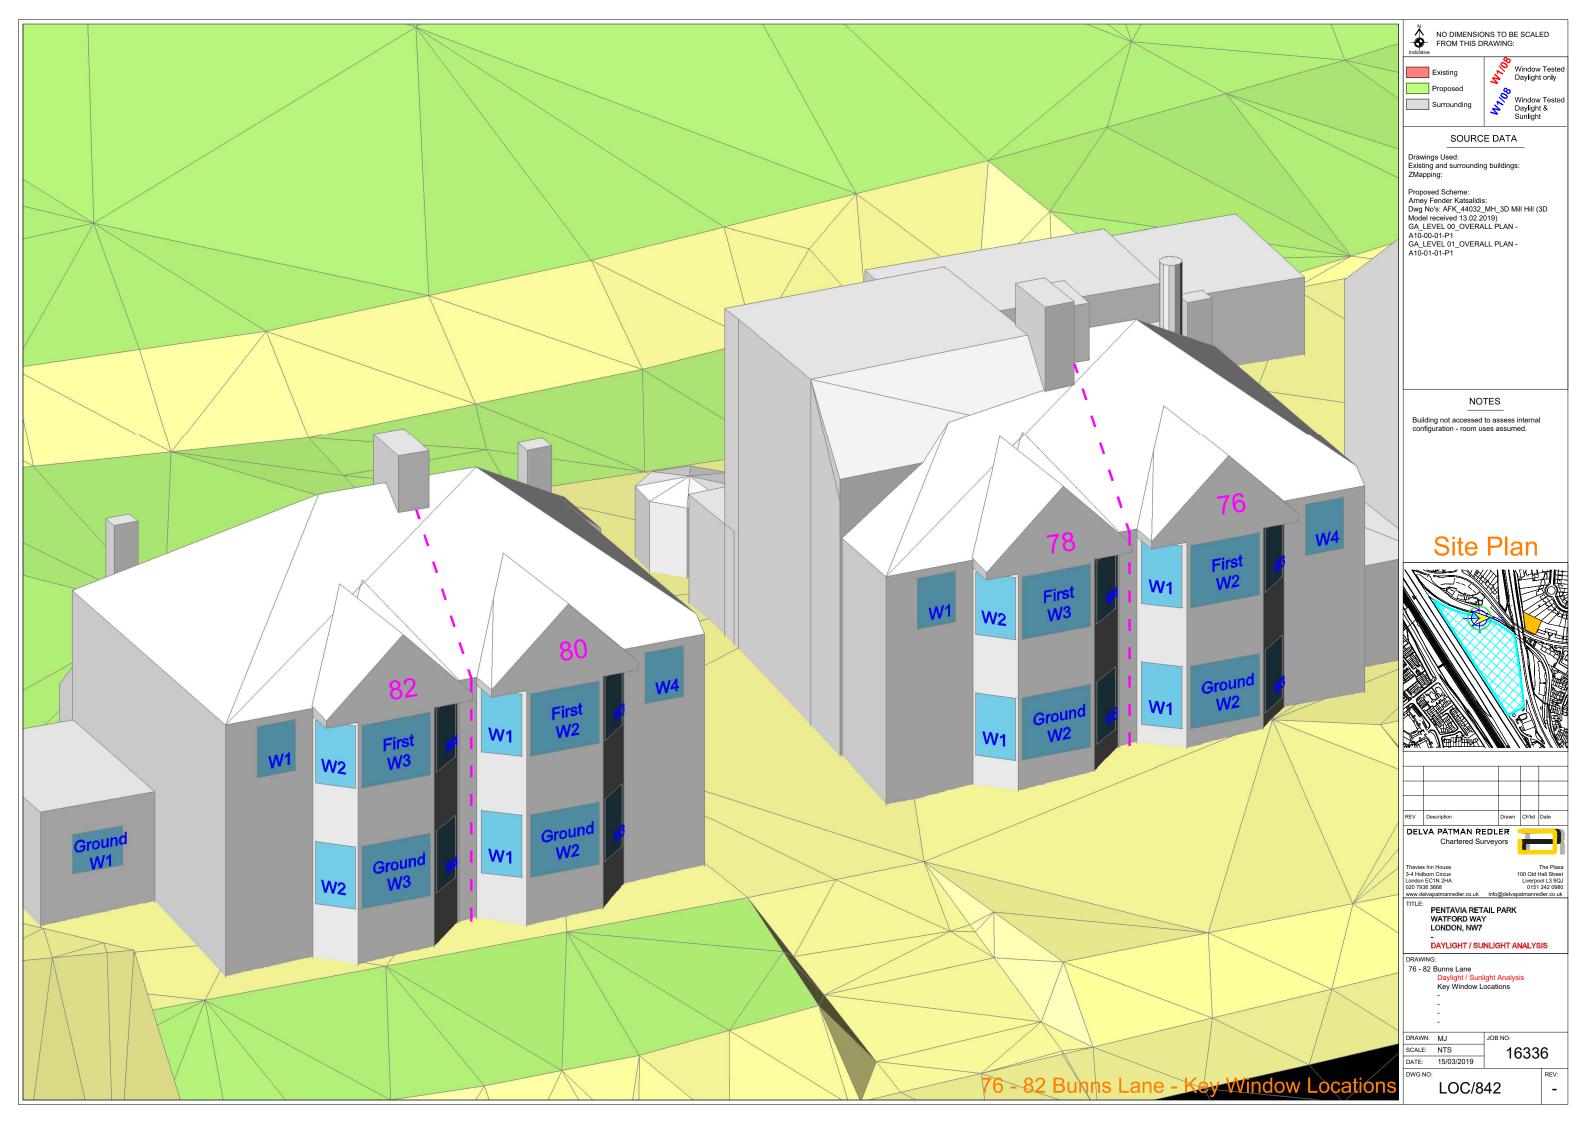






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<u>e Park</u>	TITLE: PENTAVIA RETAIL PARK WATFORD WAY LONDON, NW7
	- DRAWING:
	Pentavia Retail Park - Property Location Plan Daylight / Sunlight Analysis Existing & Proposed Schemes -
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	LOC/DS/804 -

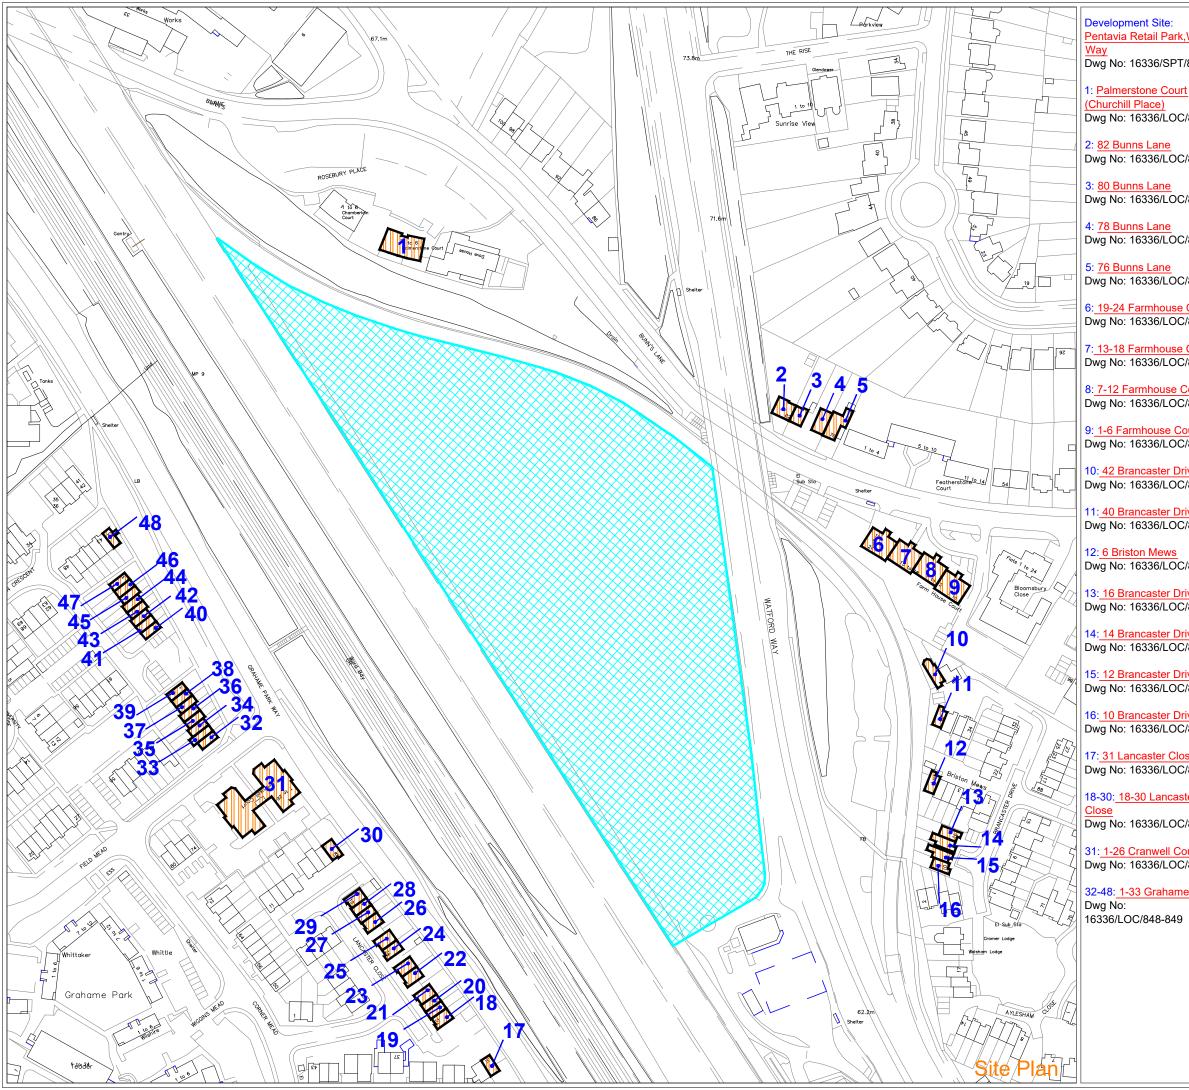





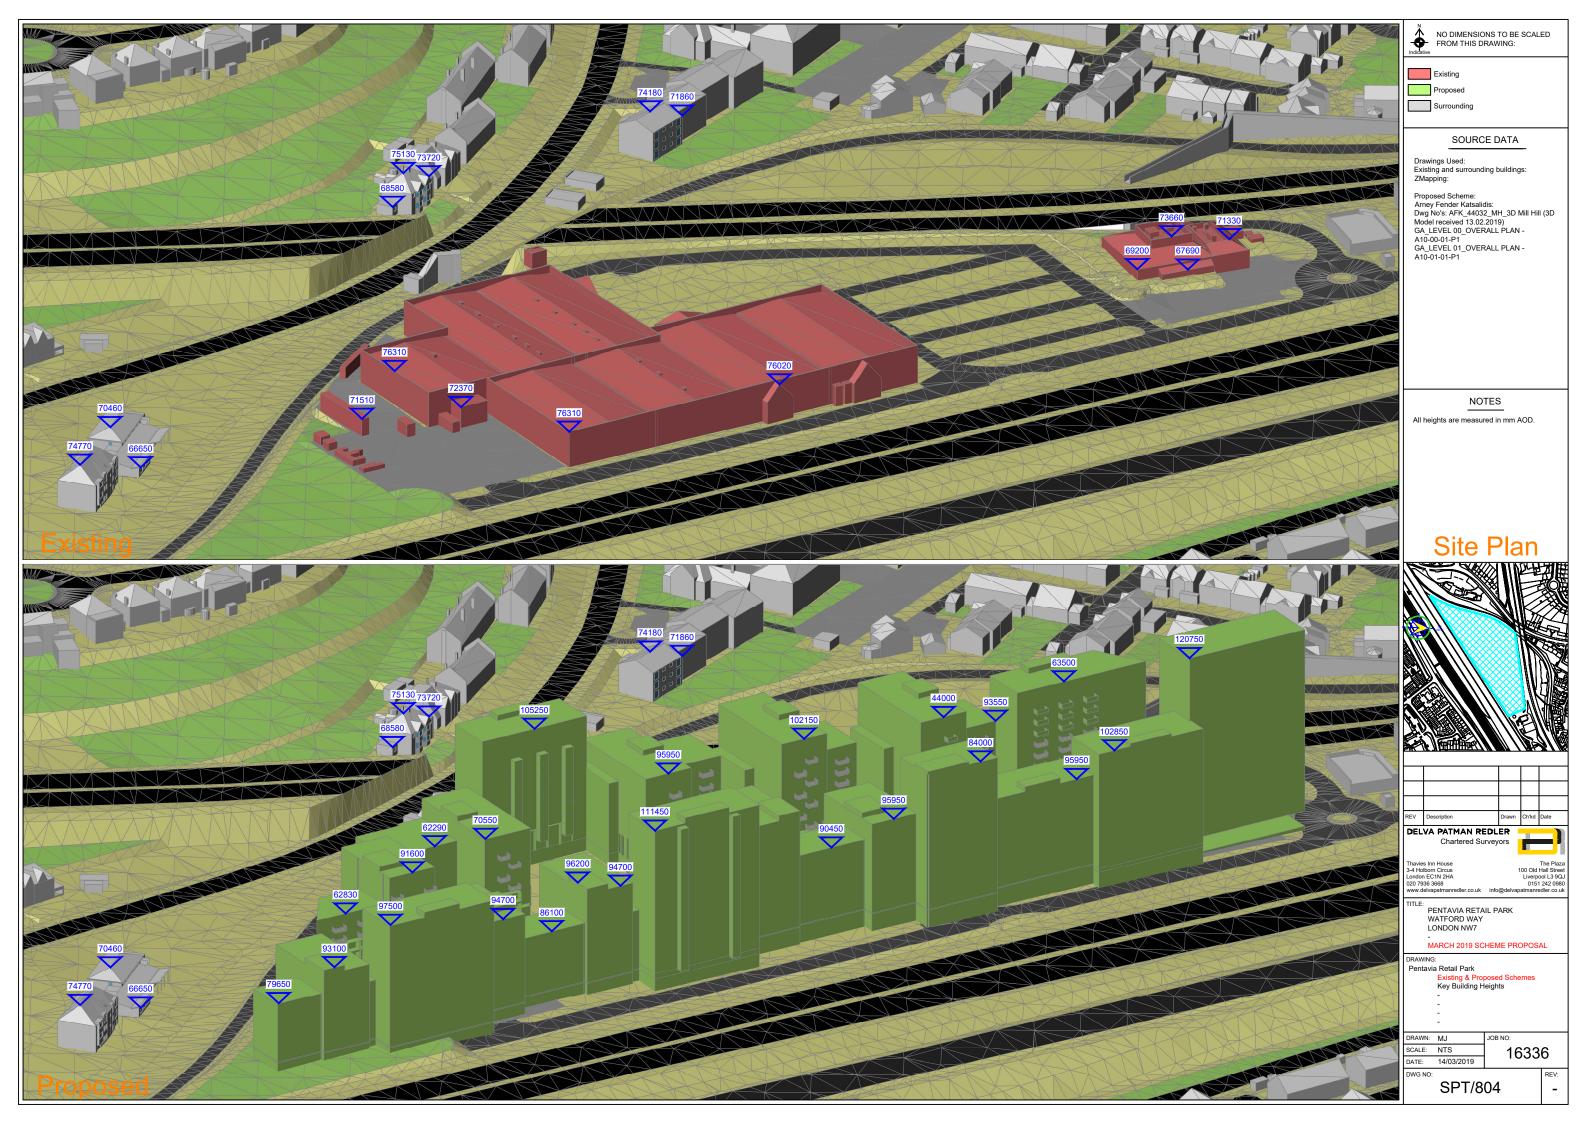


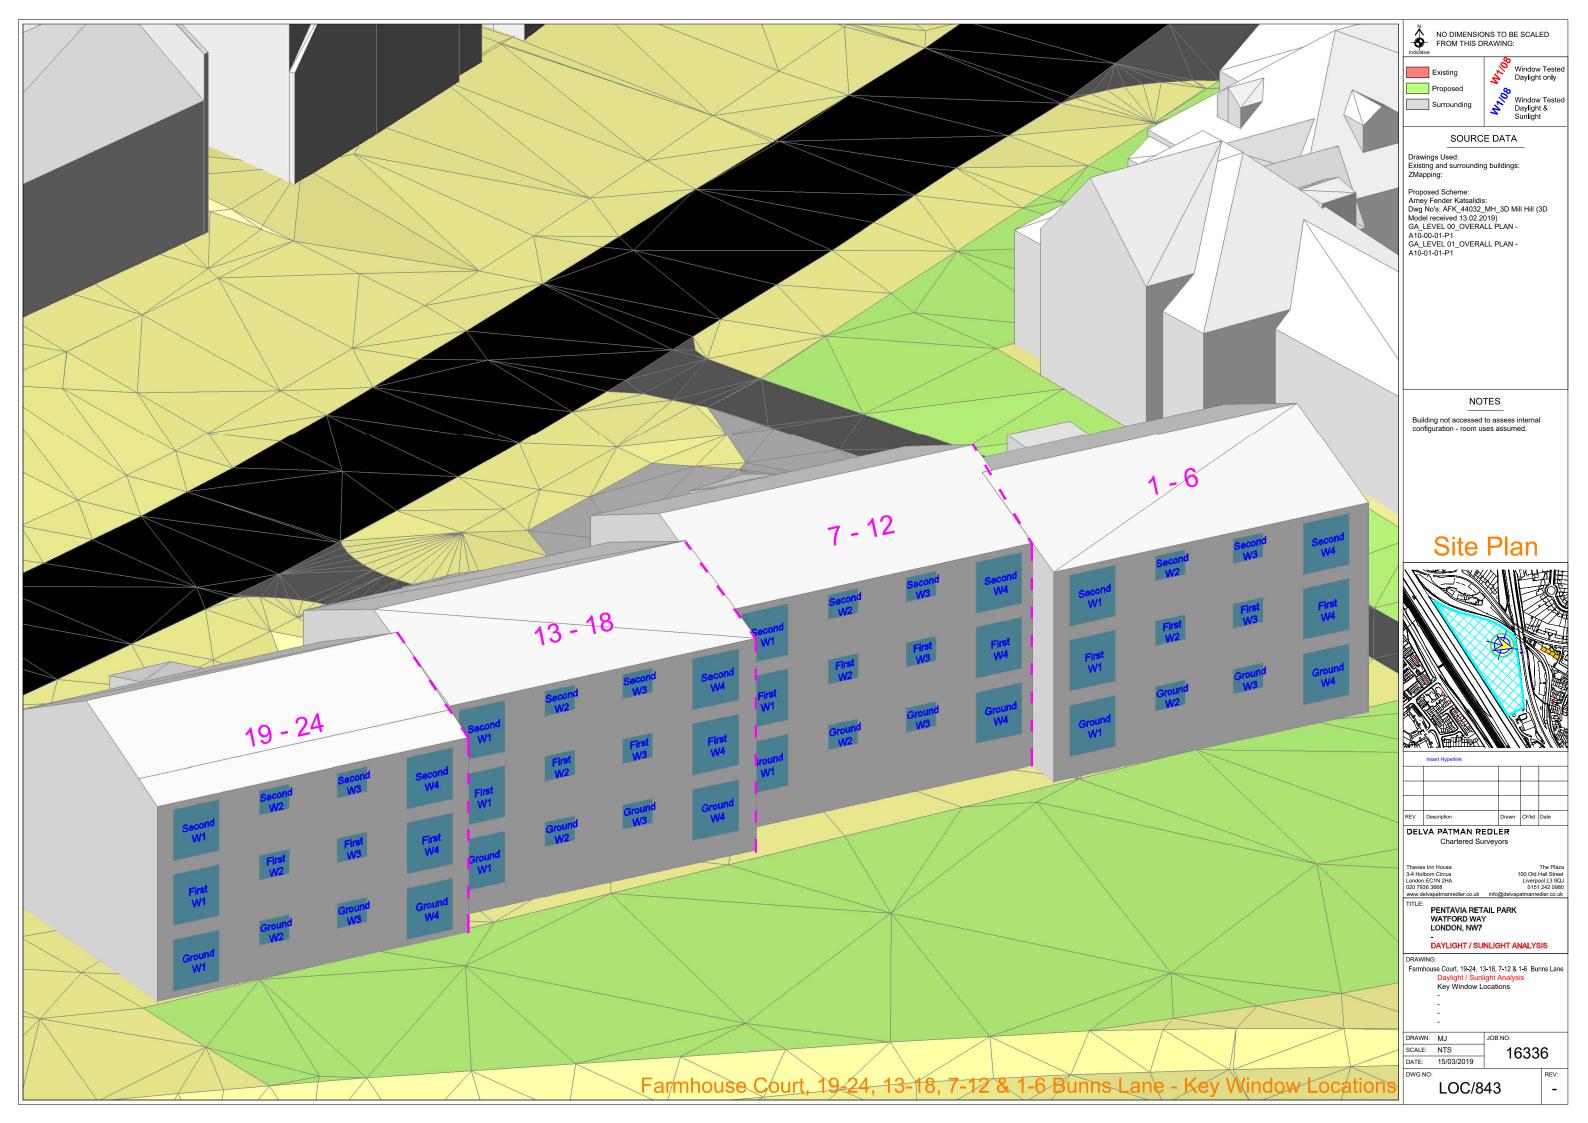


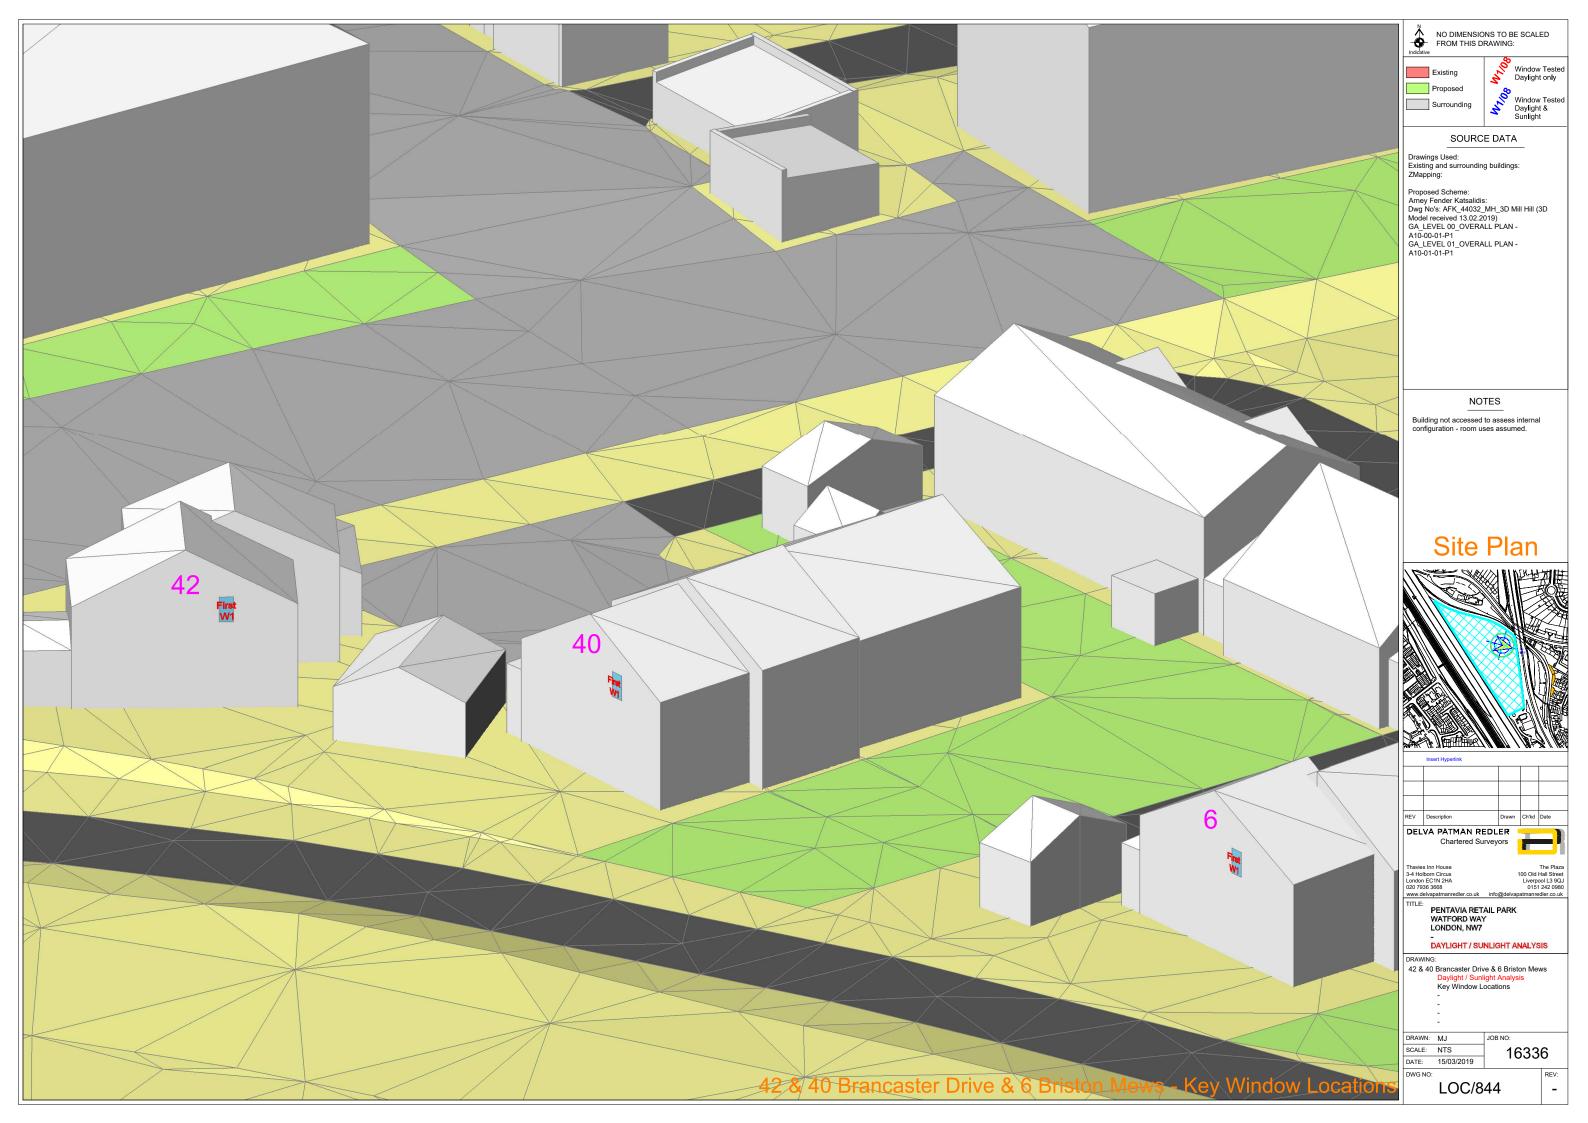


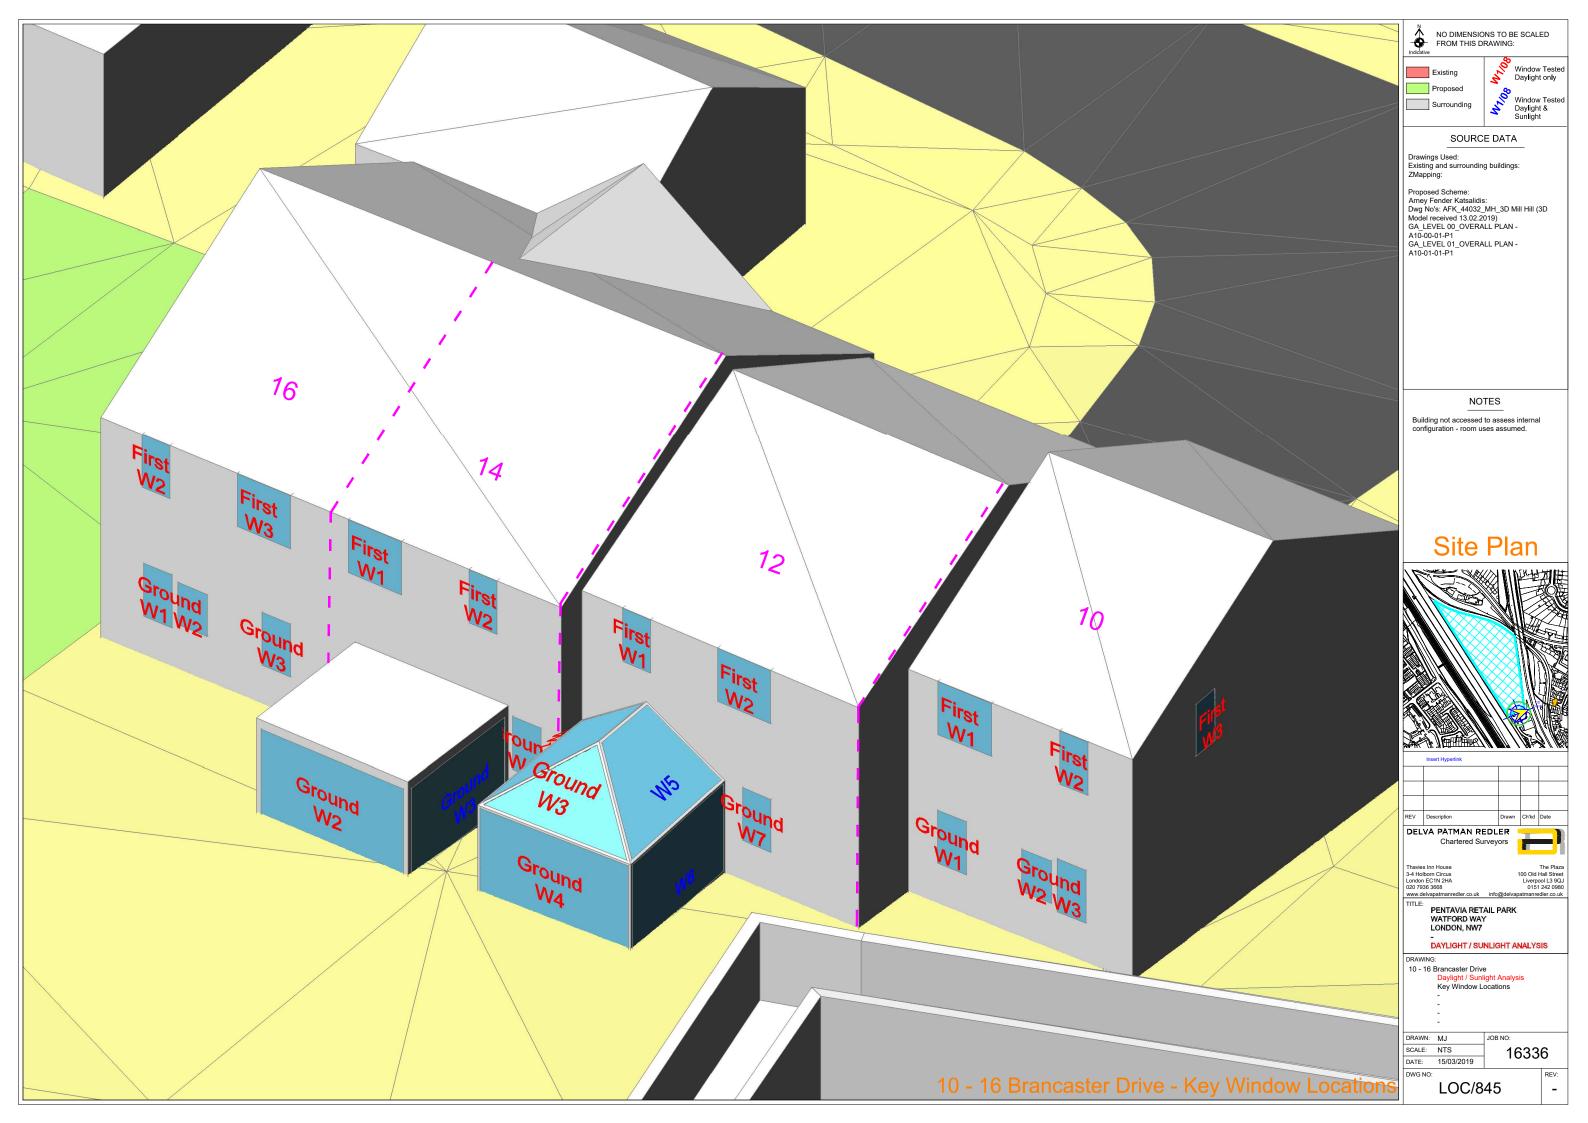

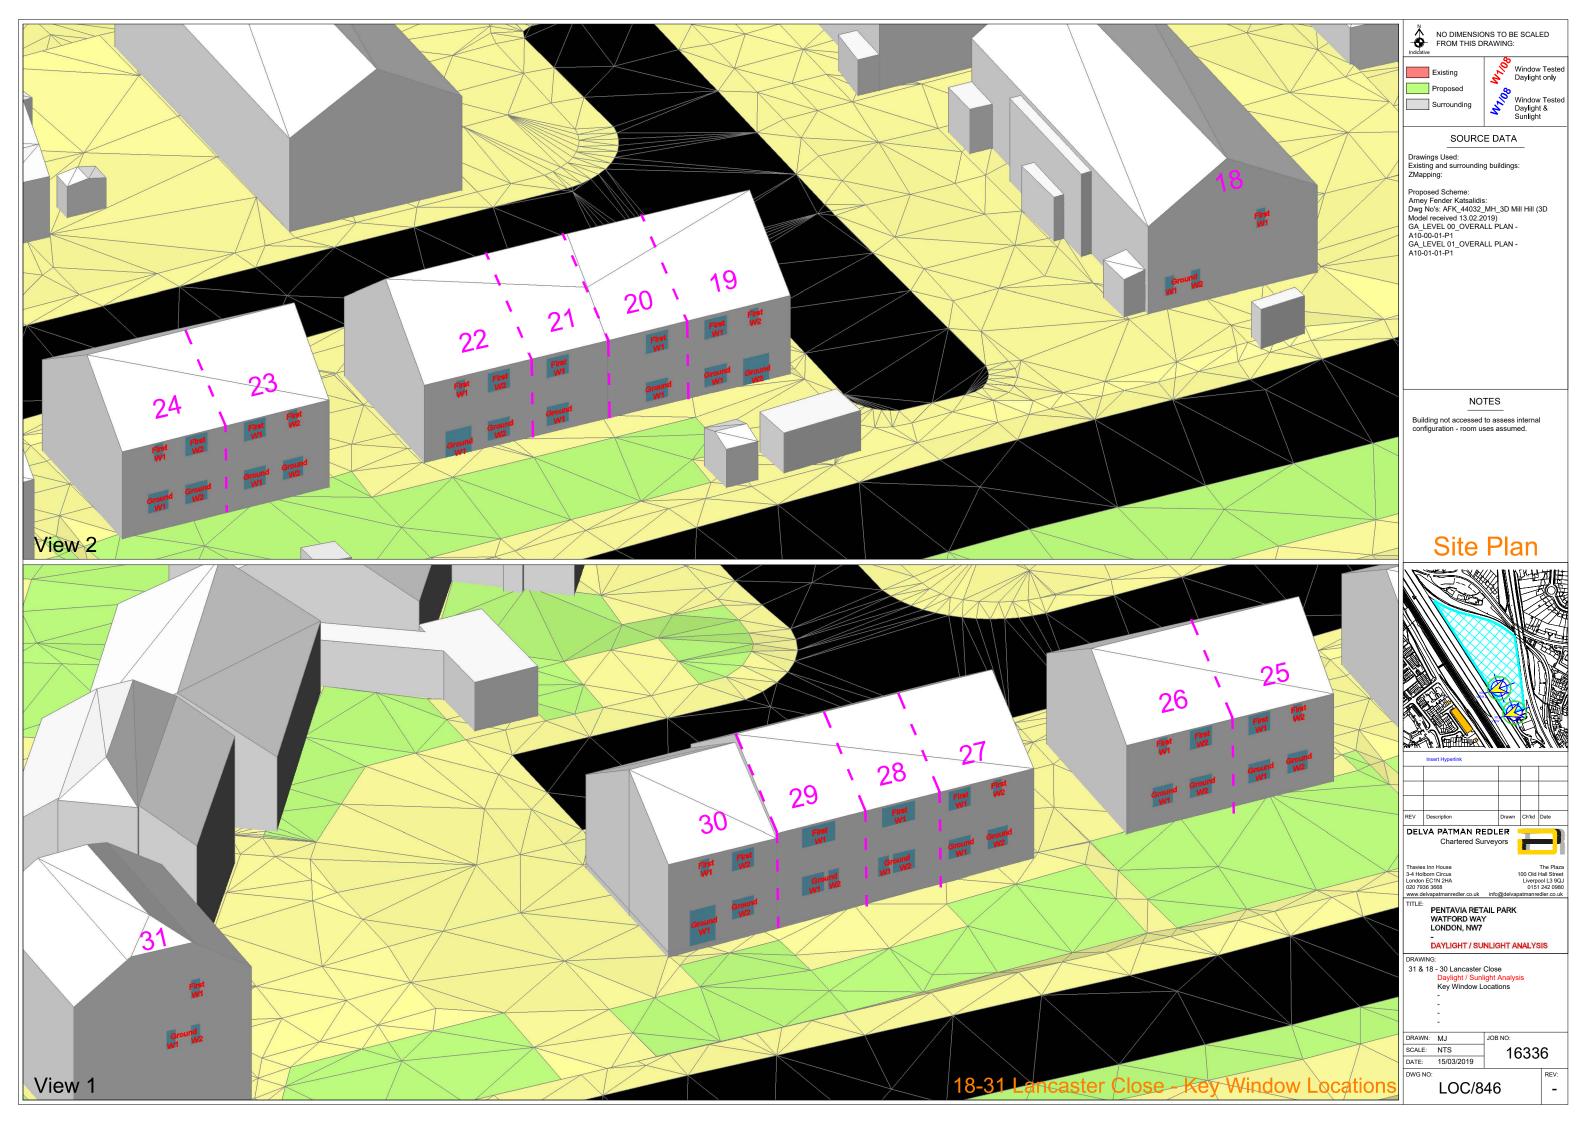

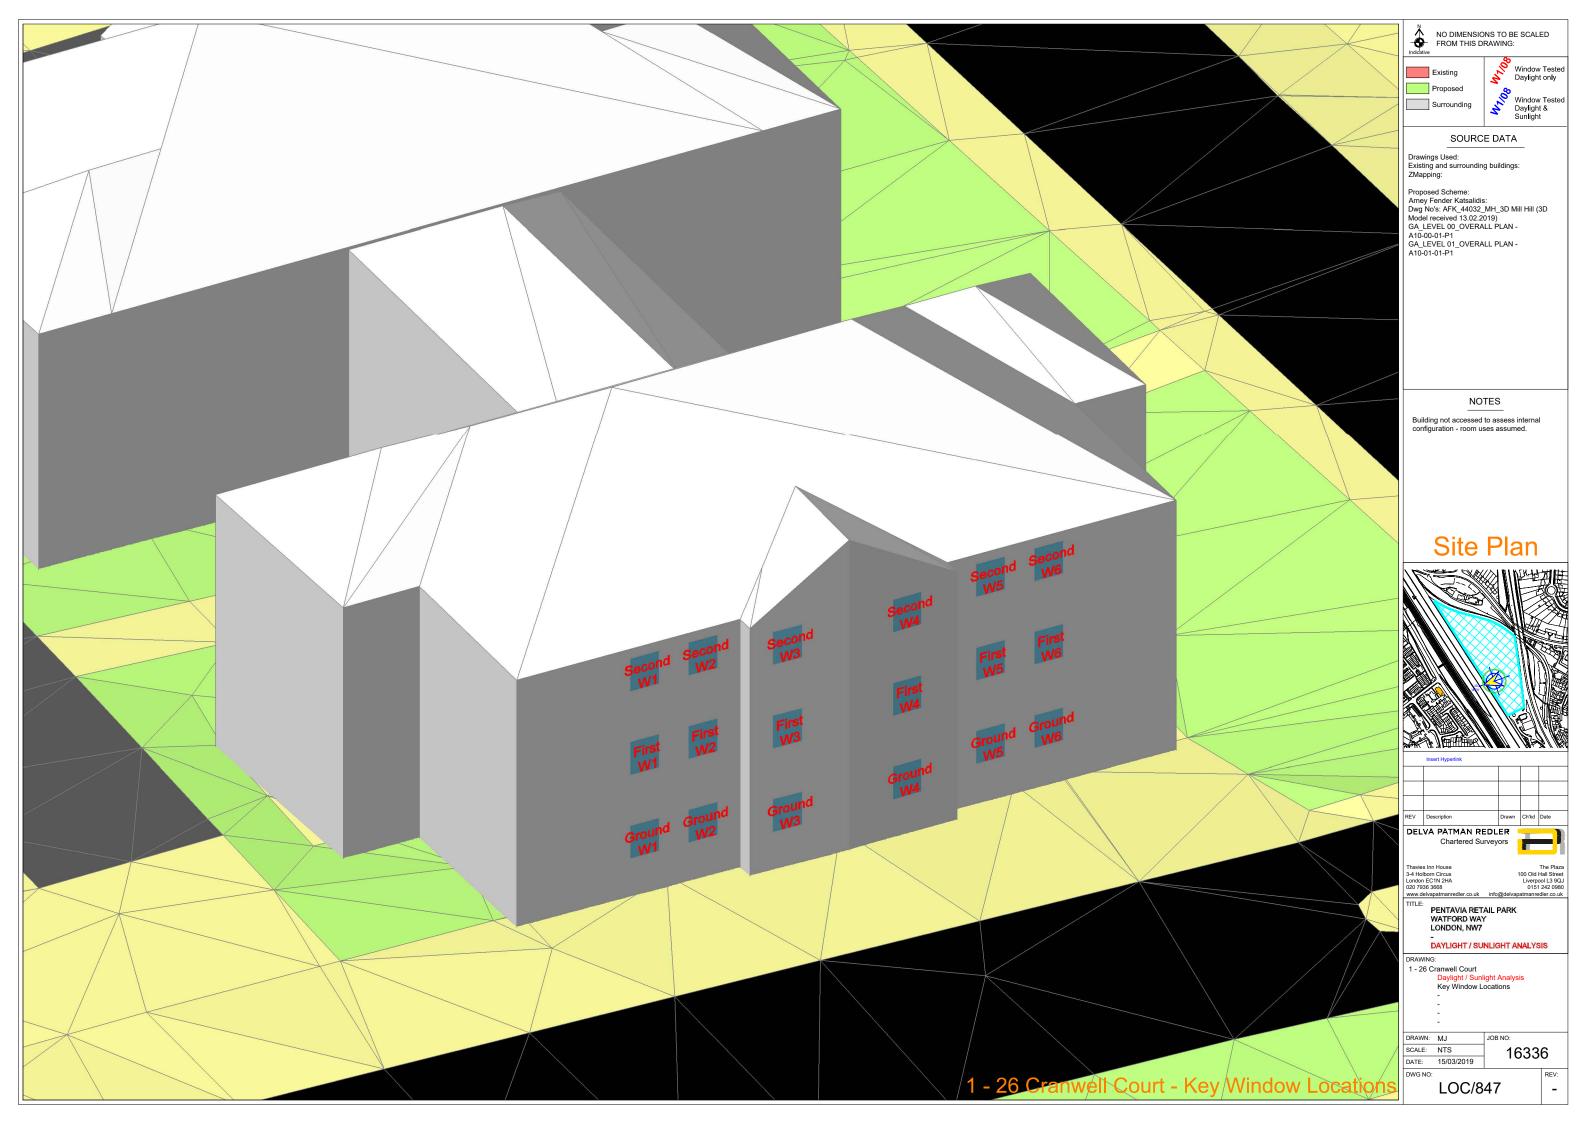

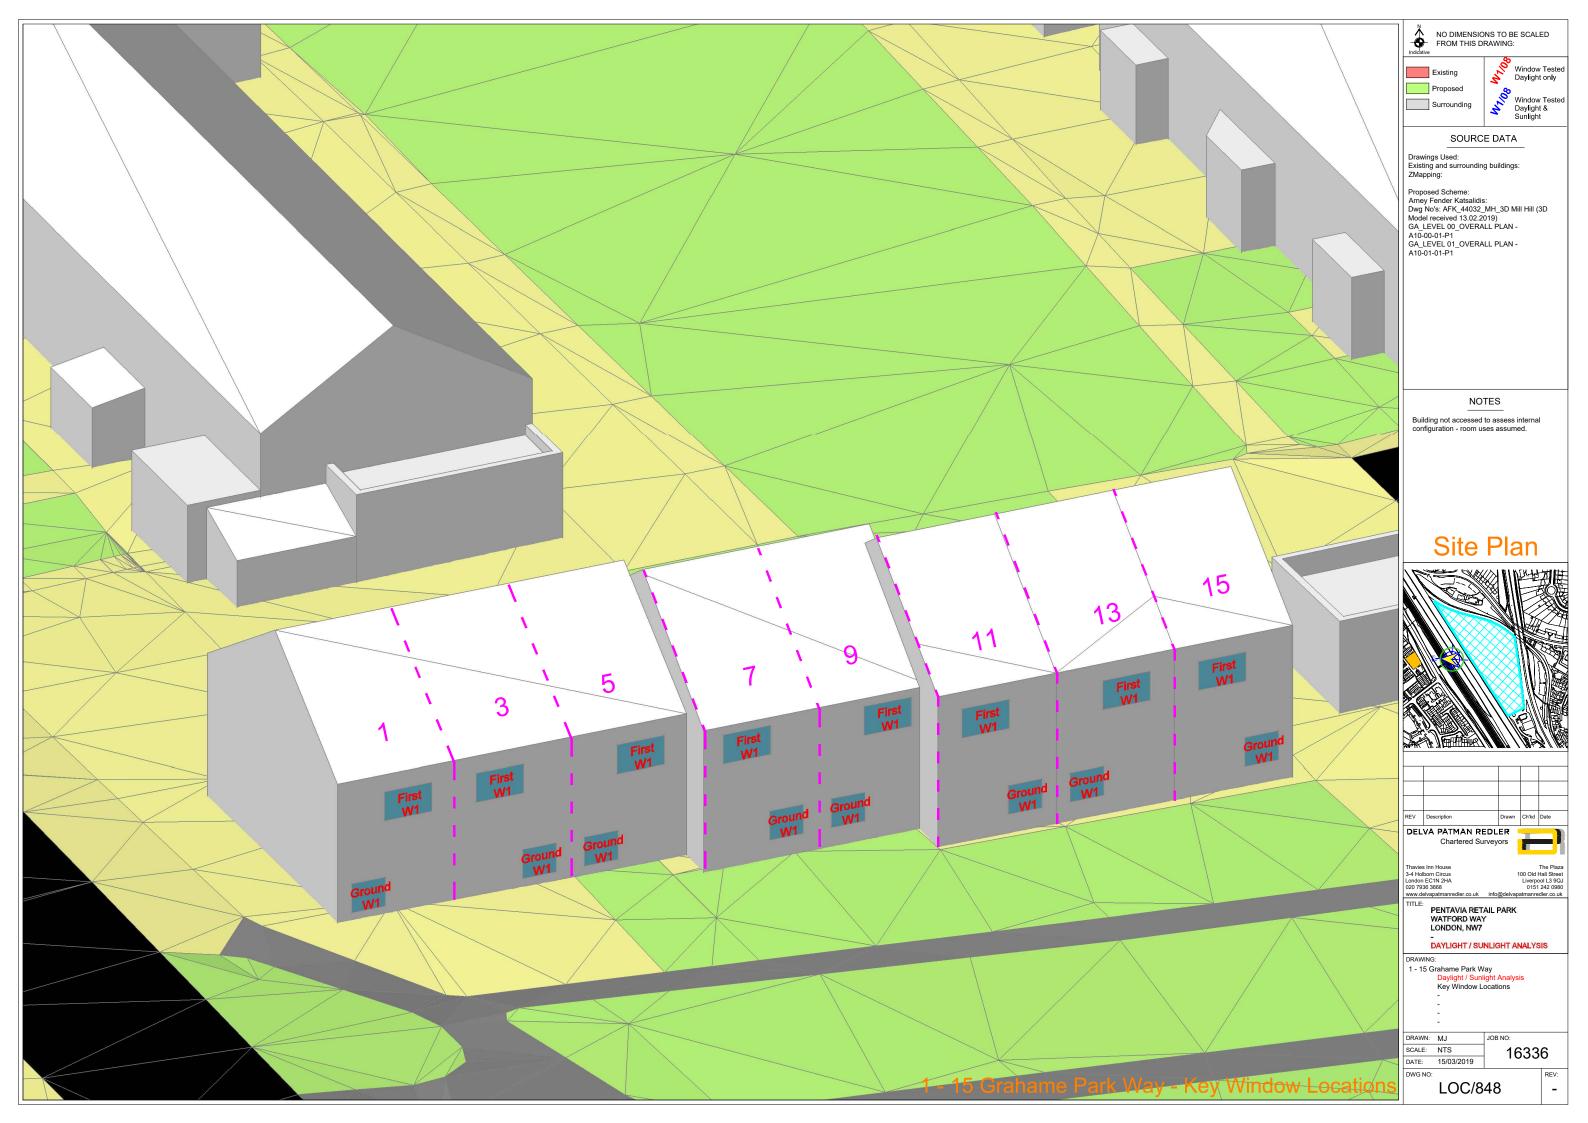

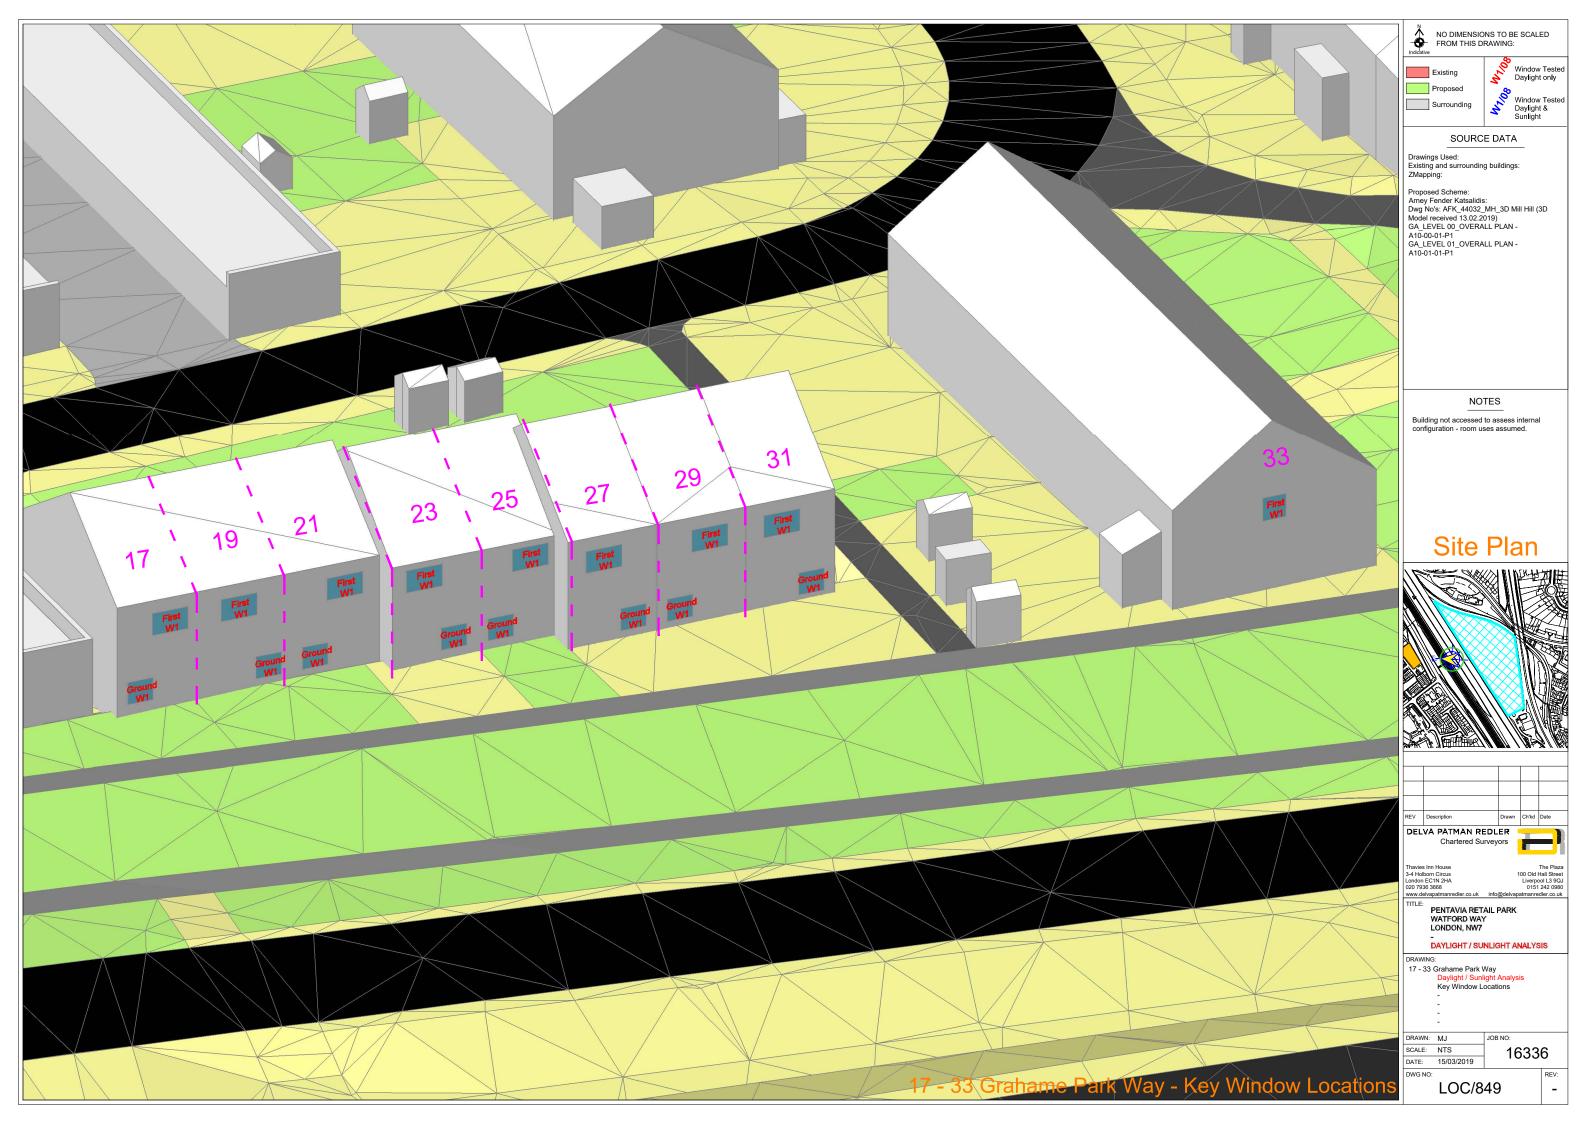

APPENDIX B

DAYLIGHT & SUNLIGHT ANALYSIS SUMMARY TABLES



	vsc					Daylight Distribution			ADF				APSH							
Address	Floor Level	Room Name	Window ID	Existing	Proposed	Window %age Diff	Room %age Diff	Existing	Proposed	%age Diff	Existing	Proposed	%age Diff	APSH Existing	APSH Proposed	%age Diff	Winter Existing	Winter Proposed	age Diff	
		LKD/R1	W1	30.82	24.53	-20.41%	-19.28%	99.48%	94.21%	-5.30%	2.01%	1.63%	-18.53%	51	43	-15.69%	28	20	-28.57%	
		ERBART	W2	36.47	29.85	-18.14%	10.2076	00.4070	04.2170	0.0070	2.0170	1.0076	10.0070	57	50	-12.28%	24	17	-29.17%	
		Bedroom/R2	W3	37.29	30.53	-18.14%	-18.31%	95.94%	89.93%	-6.26%	2.16%	1.80%	-16.62%	58	51	-12.07%	24	17	-29.17%	
	Ground	Dearooni/12	W4	37.49	30.56	-18.48%	-10.0170	33.3470	03.3376	-0.2076	2.1070	1.00 %	-10.0270	58	51	-12.07%	24	17	-29.17%	
			W6	37.42	29.64	-20.79%								58	49	-15.52%	24	15	-37.50%	
		LKD/R4	W7	36.70	28.81	-21.49%	-15.06%	99.50%	94.44%	-5.08%	2.81%	2.35%	-16.22%	73	63	-13.70%	27	17	-37.04%	
			W8	30.75	29.85	-2.90%								29	27	-6.90%	7	5	-28.57%	
		LKD/R1	W1	38.77	32.68	-15.71%	-15.71%	94.39%	83.18%	-11.88%	1.48%	1.26%	-14.71%	71	65	-8.45%	28	22	-21.43%	
Palmerstone Court		Bedroom/R2	W2	38.31	31.82	-16.95%	-17.11%	95.93%	89.69%	-6.50%	2.01%	1.69%	-15.99%	58	51	-12.07%	24	17	-29.17%	
Paimerstone Court	First	Bedioon/R2	W3	38.53	31.88	-17.27%	-17.1170	95.93%	09.09%	-0.30%	2.01%	1.09%	-15.99%	58	51	-12.07%	24	17	-29.17%	
	FIISt		W5	38.56	31.09	-19.38%								58	51	-12.07%	24	17	-29.17%	
		LKD/R4	W6	38.40	30.62	-20.25%	-14.75%	99.51%	99.51%	0.00%	2.63%	2.18%	-17.07%	74	65	-12.16%	28	19	-32.14%	
			W7	37.29	35.57	-4.61%								30	30	0.00%	6	6	0.00%	
		LKD/R1	W1	39.24	33.61	-14.34%	-14.34%	94.40%	84.71%	-10.26%	1.51%	1.30%	-13.51%	71	65	-8.45%	28	22	-21.43%	
		Bedroom/R2	W2	39.04	32.89	-15.77%	-15.77%	97.61%	91.71%	-6.05%	2.28%	1.95%	-14.61%	69	64	-7.25%	27	22	-18.52%	
	Second		W4	39.05	32.03	-17.98%								58	51	-12.07%	24	17	-29.17%	
		LKD/R4	W5	39.01	31.73	-18.67%	-13.68%	99.90%	99.90%	0.00%	3.02%	2.55%	-15.64%	74	68	-8.11%	28	22	-21.43%	
		-	W6	38.38	36.69	-4.39%								34	34	0.00%	9	9	0.00%	
		Living Room/R1	W1	25.79	19.67	-23.73%	-23.73%	96.98%	66.04%	-31.91%	0.86%	0.71%	-17.31%	40	31	-22.50%	13	7	-46.15%	
			W2	33.63	26.83	-20.22%								41	31	-24.39%	11	5	-54.55%	
	Ground	Living Room/R2	W3	37.58	31.58	-15.96%	-14.99% 10	-14.99%	100.00%	100.00%	0.00%	4.44%	3.86%	-13.13%	65	55	-15.38%	25	19	-24.00%
82 Bunns Lane		-	W4	30.95	28.23	-8.80%								49	47	-4.08%	22	20	-9.09%	
		Bedroom/R1	W1	36.83	30.50	-17.17%	-17.17%	97.84%	97.84%	0.00%	1.52%	1.29%	-15.46%	55	49	-10.91%	22	18	-18.18%	
	First		W2	33.17	26.31	-20.70%								41	34	-17.07%	12	8	-33.33%	
		Bedroom/R2	W3	38.63	32.50	-15.87%	-15.40%	100.00%	0.00% 100.00%	0.00%	0.00% 4.38%	3.79%	-13.48%	66	59	-10.61%	26	22	-15.38%	
			W4	29.66	26.81	-9.63%								42	41	-2.38%	22	21	-4.55%	
			W1	29.70	23.09	-22.24%									42	34	-19.05%	13	9	-30.77%
	Ground	Living Room/R1	W2	37.69	31.95	-15.22%	-14.72%	100.00%	100.00%	0.00%	4.43%	3.88%	-12.42%	66	59	-10.61%	25	21	-16.00%	
		3	W3	34.77	32.44	-6.71%								59	57	-3.39%	25	23	-8.00%	
80 Bunns Lane			W1	28.67	21.97	-23.36%		+		-					42	35	-16.67%	14	10	-28.57%
		Bedroom/R1	W2	38.73	32.83	-15.22%	-15.29%	100.00%	100.00%	100.00% 0.00%	0.00% 4.35%	4.35% 3.79%	.79% -12.89%	67	60	-10.45%	26	22	-15.38%	
	First		W3	33.86	31.39	-7.29%								52	51	-1.92%	25	24	-4.00%	
		Bedroom/R2	W4	37.16	31.61	-14.93%	-14.93%	97.78%	97.78%	0.00%	1.58%	1.37%	-13.40%	56	51	-8.93%	24	20	-16.67%	
		Dearooninte	W1	32.08	26.33	-17.91%	14.0076	01.1070	01.10,0	0.0070	1.00 / 0	1.0770	10.4070	38	33	-13.16%	10	7	-30.00%	
	Ground	Living Room/R1	W2	37.77	32.87	-12.97%	-12.61%	100.00%	100.00%	0.00%	4.51%	4.02%	-10.90%	65	59	-9.23%	25	21	-16.00%	
	Cround	Living Room/R	W2 W3	30.93	28.78	-6.96%	12.0170	100.0070	100.0070	0.0070	4.0170	4.0270	10.0070	49	47	-4.08%	23	20	-9.09%	
78 Bunns Lane		Bedroom/R1	W1	36.90	31.76	-13.95%	-13.95%	97.84%	97.84%	0.00%	1.57%	1.37%	-12.81%	55	49	-10.91%	22	17	-22.73%	
ro Dunno Lanc		Dealooni/TCI	W2	32.62	26.79	-17.89%	-13.3376	37.0470	37.0478	0.0078	1.0770	1.0770	-12.0170	40	33	-17.50%	12	7	-41.67%	
	First	Bedroom/R2	W2 W3	38.80	33.77	-12.96%	-12.80%	100.00%	100.00%	0.00%	4.47%	3.97%	-11.20%	66	59	-10.61%	26	21	-19.23%	
		Dealooni/12	W3 W4	29.65	27.41	-7.56%	-12.0070	100.00 /8	100.00 /8	0.00 /8	//0	5.57 /6	-11.2070	42	40	-4.76%	20	20	-9.09%	
			W1		24.47	-18.67%								42			14	20	-35.71%	
	Ground	Living Room/R1	W1 W2	30.08 37.85		-12.52%	-12.24%	100.00%	100.00%	0.00%	4.52%	4.05%	-10.41%	67	36 60	-16.28%	26	9 21	-19.23%	
	Ground		W2 W3		33.12	-12.52%	-12.2470	100.00 %	100.00 %	0.00 %	4.52 /0	4.03 %	-10.4176	56	54	-10.45%	28			
76 Bunns Lane				34.08	32.20									-		-3.57%		21	-8.70%	
70 Buillis Laile		Badraam/B1	W1	28.93	23.24	-19.68%	12 669/	100.00%	100.00%	0.00%	4.459/	2.07%	10 70%	42	35	-16.67%	14	9	-35.71%	
	First	Bedroom/R1	W2	38.84	34.00	-12.47%	-12.66%	100.00%	100.00%	0.00%	4.45%	3.97%	-10.70%	67	60	-10.45%	26	21	-19.23%	
		Dedres :: (DO	W3	33.45	31.50	-5.83%	40.040	07 70%	07 700/	0.000/	4.00%	4.449/	44.470/	50	48	-4.00%	23	21	-8.70%	
		Bedroom/R2	W4	37.22	32.67	-12.21%	-12.21%	97.78%	97.78%	0.00%	1.62%	1.44%	-11.17%	56	50	-10.71%	24	19	-20.83%	
		Living Room/R1	W1	37.72	32.66	-13.42%	-13.42%	99.80%	99.80%	0.00%	3.25%	2.84%	-12.51%	66	57	-13.64%	25	20	-20.00%	
Farm House Court	Ground	Living Room/R2	W2	38.01	33.02	-13.13%	-13.13%	96.81%	96.81%	0.00%	1.19%	1.05%	-12.32%	56	49	-12.50%	24	19	-20.83%	
19-24 Bunns Lane		Living Room/R3	W3	38.07	33.19	-12.83%	-12.83%	96.76%	96.76%	0.00%	1.20%	1.05%	-12.07%	56	49	-12.50%	24	19	-20.83%	
		Living Room/R4	W4	37.94	33.20	-12.50%	-12.50%	99.70%	99.70%	0.00%	3.26%	2.88%	-11.67%	66	59	-10.61%	25	20	-20.00%	
	First	Living Room/R1	W1	38.66	33.42	-13.54%	-13.54%	99.73%	99.73%	0.00%	3.32%	2.90%	-12.65%	66	58	-12.12%	25	20	-20.00%	

Red Text Cells do not meet the BRE recommendations Positive %age figures indicate an improvement in the natural lighting conditions

See Dwg No: 16336/LOC/841-849

Daylight / Sunlight Summary Report: Pentavia Retail Park, Watford Way, NW7 Testing: Neighbouring properties

					1	vsc			Daylight Distributio	on		ADF				АР	SH		
Address	Floor Level	Room Name	Window ID	Existing	Proposed	Window %age Diff	Room %age Diff	Existing	Proposed	%age Diff	Existing	Proposed	%age Diff	APSH Existing	APSH Proposed	%age Diff	Winter Existing	Winter Proposed	&age Diff
		Living Room/R2	W2	38.84	33.75	-13.10%	-13.10%	96.81%	96.81%	0.00%	1.22%	1.07%	-12.46%	56	49	-12.50%	24	19	-20.83%
	First	Living Room/R3	W3	38.87	33.91	-12.75%	-12.75%	96.76%	96.76%	0.00%	1.22%	1.07%	-12.14%	56	49	-12.50%	24	19	-20.83%
Farm House Court		Living Room/R4	W4	38.75	33.93	-12.45%	-12.45%	99.80%	99.79%	0.00%	3.33%	2.94%	-11.63%	66	59	-10.61%	25	20	-20.00%
19-24 Bunns Lane		Living Room/R1	W1	39.25	34.06	-13.23%	-13.23%	99.80%	99.80%	0.00%	3.36%	2.95%	-12.36%	66	59	-10.61%	25	20	-20.00%
	Second	Living Room/R2	W2	39.31	34.33	-12.68%	-12.68%	96.75%	96.75%	0.00%	1.23%	1.08%	-12.13%	56	50	-10.71%	24	20	-16.67%
		Living Room/R3	W3	39.33	34.48	-12.32%	-12.32%	96.79%	96.79%	0.00%	1.23%	1.09%	-11.81%	56	51	-8.93%	24	20	-16.67%
		Living Room/R4	W4	39.30	34.54	-12.10%	-12.10%	99.79%	99.79%	0.00%	3.37%	2.99%	-11.29%	66	61	-7.58%	25	21	-16.00%
		Living Room/R1	W1	32.60	29.12	-10.65%	-10.65%	99.10%	99.10%	0.00%	2.82%	2.59%	-8.35%	58	53	-8.62%	25	20	-20.00%
	Ground	Living Room/R2	W2	37.77	33.40	-11.55%	-11.55%	96.64%	96.64%	0.00%	1.20%	1.07%	-10.90%	56	49	-12.50%	24	19	-20.83%
		Living Room/R3	W3	38.25	33.90	-11.39%	-11.39%	96.78%	96.78%	0.00%	1.21%	1.08%	-10.84%	56	49	-12.50%	24	19	-20.83%
-		Living Room/R4	W4	38.20	33.94	-11.15%	-11.15%	99.79%	99.79%	0.00%	3.29%	2.95%	-10.42%	66	59	-10.61%	25	20	-20.00%
		Living Room/R1	W1	33.50	29.99	-10.48%	-10.48%	99.24%	99.24%	0.00%	2.89%	2.65%	-8.52%	58	53	-8.62%	25	20	-20.00%
Farm House Court 13-18 Bunns Lane	First	Living Room/R2	W2	38.70	34.34	-11.27%	-11.27%	96.66%	96.66%	0.00%	1.22%	1.09%	-10.80%	56	50	-10.71%	24	19	-20.83%
		Living Room/R3 Living Room/R4	W3 W4	39.03 38.97	34.68 34.71	-11.13%	-11.13% -10.92%	96.76% 99.79%	96.76% 99.79%	0.00%	1.23% 3.35%	1.10% 3.00%	-10.72%	56 66	50 60	-10.71% -9.09%	24 25	19 20	-20.83% -20.00%
-		Living Room/R1	W1	36.95	33.55	-9.21%	-9.21%	99.76%	99.76%	0.00%	3.23%	2.95%	-8.56%	61	57	-9.09%	25	20	-16.00%
		Living Room/R2	W1 W2	39.38	35.09	-9.21%	-9.21%	96.79%	99.78%	0.00%	1.24%	1.11%	-10.52%	56	52	-0.30%	23	21	-12.50%
	Second	Living Room/R3	W2 W3	39.41	35.22	-10.62%	-10.62%	96.78%	96.78%	0.00%	1.24%	1.11%	-10.32 %	56	52	-8.93%	24	20	-16.67%
		Living Room/R4	W3 W4	39.39	35.27	-10.46%	-10.46%	99.79%	99.79%	0.00%	3.37%	3.05%	-9.75%	66	61	-7.58%	25	20	-16.00%
		Living Room/R1	W1	31.19	28.40	-8.94%	-8.94%	98.79%	98.79%	0.00%	2.73%	2.55%	-6.81%	53	50	-5.66%	23	20	-13.04%
		Living Room/R2	W2	37.39	33.62	-10.07%	-10.07%	96.41%	96.41%	0.00%	1.19%	1.08%	-9.51%	56	50	-10.71%	24	19	-20.83%
	Ground	Living Room/R3	W3	37.49	33.69	-10.15%	-10.15%	96.52%	96.52%	0.00%	1.20%	1.08%	-9.64%	56	50	-10.71%	24	19	-20.83%
		Living Room/R4	W4	32.05	28.31	-11.66%	-11.66%	98.83%	98.83%	0.00%	2.79%	2.53%	-9.34%	49	44	-10.20%	16	12	-25.00%
-		Living Room/R1	W1	32.14	29.33	-8.74%	-8.74%	99.13%	99.13%	0.00%	2.80%	2.61%	-6.88%	53	50	-5.66%	23	20	-13.04%
Farm House Court 7-		Living Room/R2	W2	38.48	34.75	-9.69%	-9.69%	96.72%	96.72%	0.00%	1.22%	1.11%	-9.33%	56	50	-10.71%	24	19	-20.83%
12 Bunns Lane	First	Living Room/R3	W3	38.58	34.81	-9.76%	-9.76%	96.75%	96.75%	0.00%	1.22%	1.11%	-9.46%	56	50	-10.71%	24	19	-20.83%
		Living Room/R4	W4	33.01	29.30	-11.24%	-11.24%	99.23%	99.23%	0.00%	2.86%	2.59%	-9.33%	50	45	-10.00%	16	12	-25.00%
-		Living Room/R1	W1	35.56	32.89	-7.50%	-7.50%	99.64%	99.64%	0.00%	3.12%	2.91%	-6.57%	56	53	-5.36%	23	20	-13.04%
		Living Room/R2	W2	39.37	35.70	-9.33%	-9.33%	96.68%	96.68%	0.00%	1.24%	1.13%	-9.02%	56	51	-8.93%	24	20	-16.67%
	Second	Living Room/R3	W3	39.39	35.77	-9.18%	-9.18%	96.79%	96.79%	0.00%	1.24%	1.13%	-8.86%	56	51	-8.93%	24	20	-16.67%
		Living Room/R4	W4	36.31	32.76	-9.78%	-9.78%	99.64%	99.64%	0.00%	3.17%	2.89%	-8.91%	59	55	-6.78%	18	15	-16.67%
		Living Room/R1	W1	38.11	34.41	-9.70%	-9.70%	99.79%	99.79%	0.00%	3.28%	2.98%	-9.06%	66	61	-7.58%	25	21	-16.00%
	Crewed	Living Room/R2	W2	38.25	34.66	-9.38%	-9.38%	96.70%	96.70%	0.00%	1.20%	1.10%	-8.92%	56	51	-8.93%	24	20	-16.67%
	Ground	Living Room/R3	W3	38.19	34.71	-9.11%	-9.11%	96.69%	96.69%	0.00%	1.20%	1.10%	-8.67%	56	51	-8.93%	24	20	-16.67%
		Living Room/R4	W4	37.49	34.12	-9.00%	-9.00%	99.70%	99.70%	0.00%	3.25%	2.98%	-8.33%	66	62	-6.06%	25	22	-12.00%
		Living Room/R1	W1	38.97	35.29	-9.44%	-9.44%	99.72%	99.71%	0.00%	3.35%	3.05%	-8.84%	66	61	-7.58%	25	21	-16.00%
Farm House Court 1-	First	Living Room/R2	W2	39.12	35.55	-9.11%	-9.11%	96.68%	96.68%	0.00%	1.23%	1.12%	-8.76%	56	51	-8.93%	24	20	-16.67%
6 Bunns Lane	1 11 51	Living Room/R3	W3	39.11	35.65	-8.83%	-8.83%	96.74%	96.74%	0.00%	1.23%	1.12%	-8.49%	56	51	-8.93%	24	20	-16.67%
		Living Room/R4	W4	38.91	35.56	-8.62%	-8.62%	99.80%	99.80%	0.00%	3.34%	3.07%	-8.03%	66	62	-6.06%	25	22	-12.00%
		Living Room/R1	W1	39.42	35.88	-8.99%	-8.99%	99.79%	99.79%	0.00%	3.38%	3.09%	-8.39%	66	62	-6.06%	25	22	-12.00%
	Second	Living Room/R2	W2	39.46	36.06	-8.61%	-8.61%	96.70%	96.70%	0.00%	1.24%	1.14%	-8.29%	56	52	-7.14%	24	21	-12.50%
	2000110	Living Room/R3	W3	39.46	36.17	-8.35%	-8.35%	96.69%	96.69%	0.00%	1.24%	1.14%	-8.03%	56	52	-7.14%	24	21	-12.50%
		Living Room/R4	W4	39.44	36.22	-8.18%	-8.18%	99.70%	99.70%	0.00%	3.38%	3.12%	-7.61%	66	63	-4.55%	25	23	-8.00%
42 Brancaster Drive	First	Landing/R1	W1	38.61	33.17	-14.08%	-14.08%	99.15%	99.15%	0.00%	2.12%	1.84%	-13.26%	N/A	N/A	N/A	N/A	N/A	N/A
40 Brancaster Drive	First	Landing/R1	W1	38.40	33.02	-14.03%	-14.03%	99.07%	99.07%	0.00%	2.10%	1.82%	-13.38%	N/A	N/A	N/A	N/A	N/A	N/A
6 Briston Mews	First	Landing/R1	W1	38.33	32.23	-15.92%	-15.92%	99.41%	99.41%	0.00%	2.10%	1.78%	-14.98%	N/A	N/A	N/A	N/A	N/A	N/A
			W1	34.74	29.70	-14.52%								N/A	N/A	N/A	N/A	N/A	N/A
	Ground	Living Room/R1	W2	34.81	29.79	-14.42%	-14.36%	97.05%	97.03%	-0.02%	1.76%	1.54%	-12.22%	N/A	N/A	N/A	N/A	N/A	N/A
16 Brancaster Drive			W3	34.03	29.22	-14.15%								N/A	N/A	N/A	N/A	N/A	N/A
		Landing/R1	W1	34.44	34.10	-0.97%	-0.97%	98.87%	98.87%	0.00%	1.86%	1.86%	-0.12%	N/A	N/A	N/A	N/A	N/A	N/A
	First	Bedroom/R2	W2	36.93	31.66	-14.27%	-14.27%	93.49%	93.49%	0.00%	1.59%	1.39%	-13.02%	N/A	N/A	N/A	N/A	N/A	N/A
		Bedroom/R3	W3	37.00	31.74	-14.20%	-14.20%	98.38%	98.37%	-0.01%	1.96%	1.71%	-13.13%	N/A	N/A	N/A	N/A	N/A	0.00%

Red Text Cells do not meet the BRE recommendations

Positive %age figures indicate an improvement in the natural lighting conditions

						VSC			Daylight Distributio	on		ADF				AP	PSH		
Address	Floor Level	Room Name	Window ID	Existing	Proposed	Window %age Diff	Room %age Diff	Existing	Proposed	%age Diff	Existing	Proposed	%age Diff	APSH Existing	APSH Proposed	%age Diff	Winter Existing	Winter Proposed	&age Diff
			W1	21.89	21.53	-1.65%								N/A	N/A	N/A	N/A	N/A	N/A
	Ground	Living Room/R1	W2	34.15	29.29	-14.23%	-9.04%	98.39%	89.10%	-9.45%	5.16%	4.80%	-6.95%	N/A	N/A	N/A	N/A	N/A	N/A
14 Brancaster Drive	Croding	Living Roomiter	W3	15.95	14.93	-6.35%	0.0170	00.0070	0011070	011070	011070	10075	0.0070	36	33	-8.33%	1	1	0.00%
			W4	21.57	18.57	-13.94%								N/A	N/A	N/A	N/A	N/A	N/A
	First	Bedroom/R1	W1	36.91	31.70	-14.11%	-14.11%	97.31%	97.31%	0.00%	1.81%	1.58%	-13.03%	N/A	N/A	N/A	N/A	N/A	N/A
	TIISC	Bedroom/R2	W2	36.73	31.58	-14.02%	-14.02%	89.40%	89.40%	0.00%	1.58%	1.38%	-12.74%	N/A	N/A	N/A	N/A	N/A	N/A
			W1	60.58	59.78	-1.32%								N/A	N/A	N/A	N/A	N/A	N/A
			W2	10.75	10.31	-4.07%								N/A	N/A	N/A	N/A	N/A	N/A
			W3	84.24	80.62	-4.30%								N/A	N/A	N/A	N/A	N/A	N/A
	Ground	Living Room/R1	W4	32.58	28.21	-13.40%	-5.52%	96.65%	96.65%	0.00%	12.96%	12.55%	-3.12%	N/A	N/A	N/A	N/A	N/A	N/A
12 Brancaster Drive			W5	67.05	65.82	-1.85%								47	44	-6.38%	10	10	0.00%
		-	W6	20.25	19.74	-2.52%								38	36	-5.26%	8	8	0.00%
		-	W7	26.77	23.78	-11.15%								N/A	N/A	N/A	N/A	N/A	N/A
-		Bedroom/R1	W1	35.48	30.52	-13.98%	-13.98%	93.72%	93.72%	0.00%	1.55%	1.36%	-12.26%	N/A	N/A	N/A	N/A	N/A	N/A
	First	Bedroom/R2	W2	35.87	31.14	-13.18%	-13.18%	97.85%	97.84%	-0.01%	1.91%	1.68%	-11.88%	N/A	N/A	N/A	N/A	N/A	N/A
			W1	23.07	20.32	-11.94%								N/A	N/A	N/A	N/A	N/A	N/A
	Ground	Living Room/R1	W2	28.69	26.27	-8.44%	-9.36%	97.01%	96.56%	-0.46%	1.44%	1.34%	-6.90%	N/A	N/A	N/A	N/A	N/A	N/A
			W3	28.89	26.66	-7.69%	/-							N/A	N/A	N/A	N/A	N/A	N/A
10 Brancaster Drive		Bedroom/R1	W1	31.49	27.61	-12.31%	-12.31%	97.99%	97.99%	0.00%	1.66%	1.50%	-9.75%	N/A	N/A	N/A	N/A	N/A	N/A
	First	Bedroom/R2	W2	34.03	30.79	-9.52%	-9.52%	95.08%	95.08%	0.00%	1.48%	1.36%	-8.21%	N/A	N/A	N/A	N/A	N/A	N/A
	TIISC		W2 W3	34.84		-9.52%	-9.32%	98.94%	98.94%			1.89%		N/A	N/A N/A	N/A N/A	N/A N/A	N/A	N/A
		Landing/R3			34.41		-1.24%	98.94%	98.94%	0.00%	1.89%	1.89%	-0.21%	-	-				
10 1	Ground	Bedroom/R1	W1	38.10	34.18	-10.29%	-10.36%	93.95%	93.95%	0.00%	1.04%	0.94%	-9.62%	N/A	N/A	N/A	N/A	N/A	N/A
13 Lancaster Close		5.1. (5.1	W2	38.10	34.12	-10.43%	10.000/			0.000/			.	N/A	N/A	N/A	N/A	N/A	N/A
	First	Bedroom/R1	W1	38.51	34.65	-10.02%	-10.02%	80.12%	77.82%	-2.86%	0.53%	0.48%	-9.44%	N/A	N/A	N/A	N/A	N/A	N/A
	Ground	Living Room/R1	W1	36.17	31.60	-12.62%	-12.62%	99.20%	87.52%	-11.78%	1.87%	1.65%	-12.06%	N/A	N/A	N/A	N/A	N/A	N/A
30 Lancaster Close		Living Room/R2	W2	37.40	32.40	-13.38%	-13.38%	98.41%	87.98%	-10.60%	1.36%	1.19%	-12.53%	N/A	N/A	N/A	N/A	N/A	N/A
	First	Bedroom/R1	W1	38.01	33.15	-12.79%	-12.79%	92.66%	69.32%	-25.19%	0.42%	0.37%	-11.85%	N/A	N/A	N/A	N/A	N/A	N/A
		Bedroom/R2	W2	38.00	33.07	-12.98%	-12.98%	98.43%	87.70%	-10.90%	1.38%	1.21%	-12.33%	N/A	N/A	N/A	N/A	N/A	N/A
	Ground	Living Room/R1	W1	37.54	32.43	-13.60%	-13.64%	96.37%	95.99%	-0.40%	1.52%	1.33%	-12.77%	N/A	N/A	N/A	N/A	N/A	N/A
29 Lancaster Close		Ŭ	W2	37.53	32.40	-13.68%								N/A	N/A	N/A	N/A	N/A	N/A
	First	Bedroom/R1	W1	38.05	33.01	-13.23%	-13.23%	98.79%	91.37%	-7.51%	1.59%	1.39%	-12.53%	N/A	N/A	N/A	N/A	N/A	N/A
	Ground	Living Room/R1	W1	37.54	32.33	-13.88%	-13.91%	96.67%	96.29%	-0.39%	1.62%	1.41%	-13.00%	N/A	N/A	N/A	N/A	N/A	N/A
28 Lancaster Close			W2	37.54	32.30	-13.94%								N/A	N/A	N/A	N/A	N/A	N/A
	First	Bedroom/R1	W1	38.04	32.90	-13.51%	-13.51%	99.06%	90.82%	-8.32%	1.69%	1.47%	-12.79%	N/A	N/A	N/A	N/A	N/A	N/A
	Ground	Living Room/R1	W1	37.53	32.21	-14.15%	-14.15%	97.39%	94.01%	-3.47%	1.31%	1.14%	-13.26%	N/A	N/A	N/A	N/A	N/A	N/A
27 Lancaster Close	Clound	Living Room/R2	W2	37.52	32.16	-14.27%	-14.27%	96.86%	93.41%	-3.56%	1.24%	1.07%	-13.33%	N/A	N/A	N/A	N/A	N/A	N/A
27 Lancaster Close	First	Bedroom/R1	W1	38.03	32.81	-13.74%	-13.74%	99.12%	83.36%	-15.89%	1.42%	1.24%	-13.03%	N/A	N/A	N/A	N/A	N/A	N/A
	TIISC	Bedroom/R2	W2	38.04	32.78	-13.84%	-13.84%	92.88%	69.27%	-25.42%	0.45%	0.39%	-12.84%	N/A	N/A	N/A	N/A	N/A	N/A
	Ground	Living Room/R1	W1	37.47	31.94	-14.75%	-14.75%	96.82%	93.04%	-3.91%	1.33%	1.15%	-13.74%	N/A	N/A	N/A	N/A	N/A	N/A
	Ground	Living Room/R2	W2	37.47	31.92	-14.82%	-14.82%	97.22%	93.67%	-3.65%	1.33%	1.14%	-13.78%	N/A	N/A	N/A	N/A	N/A	N/A
26 Lancaster Close		Bedroom/R1	W1	38.02	32.58	-14.32%	-14.32%	93.41%	66.48%	-28.83%	0.45%	0.39%	-13.28%	N/A	N/A	N/A	N/A	N/A	N/A
	First	Bedroom/R2	W2	38.00	32.52	-14.42%	-14.42%	98.75%	84.07%	-14.87%	1.34%	1.16%	-13.60%	N/A	N/A	N/A	N/A	N/A	N/A
		Living Room/R1	W1	37.47	31.86	-14.96%	-14.96%	97.63%	94.02%	-3.69%	1.43%	1.23%	-13.93%	N/A	N/A	N/A	N/A	N/A	N/A
	Ground	Living Room/R2	W2	37.46	31.83	-15.05%	-15.05%	97.07%	92.84%	-4.36%	1.33%	1.14%	-13.99%	N/A	N/A	N/A	N/A	N/A	N/A
25 Lancaster Close		Bedroom/R1	W1	37.99	32.46	-14.57%	-14.57%	99.09%	82.39%	-16.85%	1.45%	1.25%	-13.71%	N/A	N/A	N/A	N/A	N/A	N/A
	First	Bedroom/R2	W2	38.00	32.44	-14.63%	-14.63%	92.94%	66.68%	-28.25%	0.45%	0.39%	-13.58%	N/A	N/A	N/A	N/A	N/A	N/A
		Living Room/R1	W1	37.40	31.69	-15.26%	-15.26%	96.82%	95.64%	-1.22%	1.33%	1.14%	-14.12%	N/A	N/A	N/A	N/A	N/A	N/A
	Ground	Living Room/R2	W2	37.40	31.68	-15.30%	-15.30%	97.21%	93.85%	-3.46%	1.33%	1.14%	-14.20%	N/A	N/A	N/A	N/A	N/A	N/A
24 Lancaster Close		Bedroom/R1	W1	37.97	32.33	-14.86%	-14.86%	93.36%	70.29%	-24.71%	0.45%	0.39%	-13.80%	N/A	N/A	N/A	N/A	N/A	N/A
	First	Bedroom/R2	W1 W2	37.94	32.33	-14.91%	-14.91%	98.75%	82.64%	-16.31%	1.34%	1.15%	-14.03%	N/A	N/A	N/A	N/A	N/A	N/A
			W1	37.39		-14.91%	-14.91%	97.63%				1.15%		N/A	-		N/A N/A	N/A	-
23 Lancaster Close	Ground	Living Room/R1			31.64				95.07%	-2.62%	1.43%		-14.23%		N/A	N/A			N/A
		Living Room/R2	W2	37.38	31.63	-15.39%	-15.39%	97.07%	92.29%	-4.92%	1.33%	1.14%	-14.25%	N/A	N/A	N/A	N/A	N/A	N/A

Red Text Cells do not meet the BRE recommendations

Positive %age figures indicate an improvement in the natural lighting conditions

Daylight / Sunlight Summary Report: Pentavia Retail Park, Watford Way, NW7 Testing: Neighbouring properties

						/SC			Daylight Distributio	on		ADF				AP	SH		
Address	Floor Level	Room Name	Window ID	Existing	Proposed	Window %age Diff	Room %age Diff	Existing	Proposed	%age Diff	Existing	Proposed	%age Diff	APSH Existing	APSH Proposed	%age Diff	Winter Existing	Winter Proposed	&age Diff
23 Lancaster Close	First	Bedroom/R1	W1	37.93	32.25	-14.99%	-14.99%	99.09%	81.90%	-17.35%	1.45%	1.24%	-14.09%	N/A	N/A	N/A	N/A	N/A	N/A
	- Hot	Bedroom/R2	W2	37.94	32.25	-15.01%	-15.01%	92.86%	65.02%	-29.97%	0.45%	0.39%	-13.97%	N/A	N/A	N/A	N/A	N/A	N/A
	Ground	Living Room/R1	W1	34.81	30.37	-12.74%	-12.74%	99.20%	86.76%	-12.54%	1.83%	1.60%	-12.67%	N/A	N/A	N/A	N/A	N/A	N/A
22 Lancaster Close	Croand	Living Room/R2	W2	36.34	31.12	-14.36%	-14.36%	98.41%	81.02%	-17.67%	1.32%	1.15%	-13.06%	N/A	N/A	N/A	N/A	N/A	N/A
22 Lancaster Close	First	Bedroom/R1	W1	37.78	32.02	-15.24%	-15.24%	92.71%	71.68%	-22.68%	0.42%	0.36%	-14.11%	N/A	N/A	N/A	N/A	N/A	N/A
	FIISC	Bedroom/R2	W2	37.75	31.99	-15.27%	-15.27%	98.44%	80.62%	-18.10%	1.37%	1.17%	-14.26%	N/A	N/A	N/A	N/A	N/A	N/A
01.1	Ground	Living Room/R1	W1	36.14	31.09	-13.96%	-13.96%	96.97%	81.47%	-15.98%	1.12%	0.98%	-12.68%	N/A	N/A	N/A	N/A	N/A	N/A
21 Lancaster Close -	First	Bedroom/R1	W1	37.74	31.97	-15.29%	-15.29%	97.18%	81.45%	-16.19%	1.17%	1.00%	-14.30%	N/A	N/A	N/A	N/A	N/A	N/A
00.1	Ground	Living Room/R1	W1	35.31	30.90	-12.49%	-12.49%	97.02%	86.90%	-10.43%	1.10%	0.97%	-11.27%	N/A	N/A	N/A	N/A	N/A	N/A
20 Lancaster Close -	First	Bedroom/R1	W1	37.71	31.93	-15.33%	-15.33%	97.03%	86.44%	-10.92%	1.17%	1.00%	-14.30%	N/A	N/A	N/A	N/A	N/A	N/A
		Living Room/R1	W1	34.06	30.41	-10.70%	-10.70%	98.25%	91.48%	-6.89%	1.25%	1.13%	-9.42%	N/A	N/A	N/A	N/A	N/A	N/A
	Ground	Living Room/R2	W2	27.95	26.43	-5.46%	-5.46%	98.98%	88.23%	-10.85%	1.59%	1.49%	-6.33%	N/A	N/A	N/A	N/A	N/A	N/A
19 Lancaster Close		Bedroom/R1	W1	37.69	31.92	-15.32%	-15.32%	98.29%	91.33%	-7.08%	1.37%	1.17%	-14.30%	N/A	N/A	N/A	N/A	N/A	N/A
	First	Bedroom/R2	W2	37.70	31.94	-15.28%	-15.28%	92.70%	69.53%	-25.00%	0.42%	0.36%	-14.16%	N/A	N/A	N/A	N/A	N/A	N/A
			W1	36.79	31.13	-15.39%								N/A	N/A	N/A	N/A	N/A	N/A
18 Lancaster Close	Ground	Landing/R1	W2	36.80	31.16	-15.34%	-15.36%	94.91%	94.91%	0.00%	1.01%	0.87%	-13.97%	N/A	N/A	N/A	N/A	N/A	N/A
	First	Landing/R1	W1	37.54	31.77	-15.37%	-15.37%	79.02%	78.80%	-0.28%	0.51%	0.44%	-14.18%	N/A	N/A	N/A	N/A	N/A	N/A
		g	W1	36.41	31.03	-14.79%								N/A	N/A	N/A	N/A	N/A	N/A
		Living Room/R1	W2	34.73	29.38	-15.42%	-15.11%	98.56%	88.49%	-10.22%	1.33%	1.15%	-13.27%	N/A	N/A	N/A	N/A	N/A	N/A
		Living Room/R2	W3	36.75	31.39	-14.61%	-14.61%	96.14%	78.50%	-18.35%	0.90%	0.78%	-13.32%	N/A	N/A	N/A	N/A	N/A	N/A
	Ground	Living Room/R3	W4	36.74	31.47	-14.37%	-14.37%	97.13%	85.65%	-11.82%	0.90%	0.78%	-13.14%	N/A	N/A	N/A	N/A	N/A	N/A
		Living Room/RS					-14.37%	97.13%	05.03%	-11.02%	0.90%	0.78%	-13.14%					-	
		Living Room/R4	W5	35.23	30.00	-14.85%	-14.57%	98.45%	89.74%	-8.85%	1.34%	1.17%	-12.96%	N/A	N/A	N/A	N/A	N/A	N/A
-			W6	36.42	31.22	-14.29%								N/A	N/A	N/A	N/A	N/A	N/A
		Living Room/R1	W1	37.10	31.66	-14.65%	-14.97%	98.56%	93.73%	-4.90%	1.35%	1.17%	-13.44%	N/A	N/A	N/A	N/A	N/A	N/A
			W2	35.40	29.99	-15.28%								N/A	N/A	N/A	N/A	N/A	N/A
1-26 Cranwell Court	First	Living Room/R2	W3	37.39	31.97	-14.51%	-14.51%	96.14%	84.30%	-12.32%	0.92%	0.79%	-13.47%	N/A	N/A	N/A	N/A	N/A	N/A
		Living Room/R3	W4	37.39	32.05	-14.27%	-14.27%	97.13%	90.26%	-7.07%	0.92%	0.80%	-13.29%	N/A	N/A	N/A	N/A	N/A	N/A
		Living Room/R4	W5	35.89	30.61	-14.71%	-14.44%	98.45%	93.68%	-4.85%	1.36%	1.18%	-13.11%	N/A	N/A	N/A	N/A	N/A	N/A
-			W6	37.11	31.86	-14.16%								N/A	N/A	N/A	N/A	N/A	N/A
		Living Room/R1	W1	37.83	32.42	-14.29%	-14.46%	98.64%	96.33%	-2.34%	1.38%	1.20%	-13.40%	N/A	N/A	N/A	N/A	N/A	N/A
		-	W2	36.79	31.41	-14.63%								N/A	N/A	N/A	N/A	N/A	N/A
	Second	Living Room/R2	W3	37.94	32.55	-14.23%	-14.23%	96.14%	87.56%	-8.93%	0.93%	0.81%	-13.45%	N/A	N/A	N/A	N/A	N/A	N/A
		Living Room/R3	W4	37.94	32.63	-14.00%	-14.00%	97.13%	92.45%	-4.82%	0.93%	0.81%	-13.26%	N/A	N/A	N/A	N/A	N/A	N/A
		Living Room/R4	W5	37.16	31.90	-14.16%	-14.00%	98.49%	96.47%	-2.05%	1.39%	1.21%	-13.09%	N/A	N/A	N/A	N/A	N/A	N/A
			W6	37.83	32.59	-13.84%								N/A	N/A	N/A	N/A	N/A	N/A
1 Grahame Park	Ground	Living Room/R1	W1	36.04	32.16	-10.76%	-10.76%	99.22%	99.22%	0.00%	1.51%	1.36%	-9.95%	N/A	N/A	N/A	N/A	N/A	N/A
Way	First	Bedroom/R1	W1	37.27	33.10	-11.19%	-11.19%	98.62%	98.62%	0.00%	1.45%	1.30%	-10.58%	N/A	N/A	N/A	N/A	N/A	N/A
3 Grahame Park	Ground	Living Room/R1	W1	36.24	32.18	-11.21%	-11.21%	99.00%	98.95%	-0.06%	1.53%	1.37%	-10.33%	N/A	N/A	N/A	N/A	N/A	N/A
Way	First	Bedroom/R1	W1	37.31	33.19	-11.05%	-11.05%	98.49%	98.49%	0.00%	1.60%	1.43%	-10.48%	N/A	N/A	N/A	N/A	N/A	N/A
5 Grahame Park	Ground	Living Room/R1	W1	35.25	31.22	-11.43%	-11.43%	99.04%	98.97%	-0.06%	1.49%	1.34%	-10.20%	N/A	N/A	N/A	N/A	N/A	N/A
Way	First	Bedroom/R1	W1	34.58	30.54	-11.68%	-11.68%	96.82%	96.82%	0.00%	1.44%	1.29%	-10.16%	N/A	N/A	N/A	N/A	N/A	N/A
7 Grahame Park	Ground	Living Room/R1	W1	36.28	32.29	-10.99%	-10.99%	99.00%	99.00%	0.00%	1.53%	1.38%	-10.15%	N/A	N/A	N/A	N/A	N/A	N/A
Way	First	Bedroom/R1	W1	37.47	33.43	-10.78%	-10.78%	98.69%	98.69%	0.00%	1.61%	1.44%	-10.25%	N/A	N/A	N/A	N/A	N/A	N/A
9 Grahame Park	Ground	Living Room/R1	W1	34.58	30.63	-11.42%	-11.42%	99.07%	99.07%	0.00%	1.46%	1.32%	-9.96%	N/A	N/A	N/A	N/A	N/A	N/A
Way	First	Bedroom/R1	W1	31.90	27.93	-12.44%	-12.44%	95.36%	95.36%	0.00%	1.34%	1.21%	-9.94%	N/A	N/A	N/A	N/A	N/A	N/A
11 Grahame Park	Ground	Living Room/R1	W1	36.88	32.96	-10.63%	-10.63%	99.17%	99.17%	0.00%	1.54%	1.39%	-10.00%	N/A	N/A	N/A	N/A	N/A	N/A
Way	First	Bedroom/R1	W1	37.58	33.60	-10.58%	-10.58%	98.70%	98.70%	0.00%	1.56%	1.40%	-10.11%	N/A	N/A	N/A	N/A	N/A	N/A
13 Grahame Park	Ground	Living Room/R1	W1	36.88	32.99	-10.53%	-10.53%	99.11%	99.11%	0.00%	1.54%	1.39%	-9.95%	N/A	N/A	N/A	N/A	N/A	N/A
Way	First	Bedroom/R1	W1	37.58	33.68	-10.38%	-10.38%	98.38%	98.38%	0.00%	1.56%	1.41%	-9.92%	N/A	N/A	N/A	N/A	N/A	N/A
	Ground	Living Room/R1	W1	36.83	33.04	-10.28%	-10.28%	99.00%	99.00%	0.00%	1.54%	1.39%	-9.92 %	N/A	N/A	N/A	N/A	N/A	N/A
15 Grahame Park Way	First	Bedroom/R1	W1	37.58	33.73	-10.28%	-10.28%	98.65%	98.65%	0.00%	1.54%	1.33%	-9.71%	N/A	N/A N/A	N/A	N/A	N/A N/A	N/A N/A
17 Grahame Park																			
W/av	Ground	Kitchen/R1	W1	36.92	33.38	-9.58%	-9.58%	99.22%	99.22%	0.00%	1.54%	1.40%	-9.09%	N/A	N/A	N/A	N/A	N/A	N/A

Red Text Cells do not meet the BRE recommendations

Positive %age figures indicate an improvement in the natural lighting conditions

					vsc			Daylight Distribution				ADF				AP	РSH		
Address	Floor Level	Room Name	Window ID	Existing	Proposed	Window %age Diff	Room %age Diff	Existing	Proposed	%age Diff	Existing	Proposed	%age Diff	APSH Existing	APSH Proposed	%age Diff	Winter Existing	Winter Proposed	&age Diff
17 Grahame Park Way	First	Bedroom/R1	W1	37.68	34.13	-9.42%	-9.42%	98.62%	98.62%	0.00%	1.46%	1.33%	-9.08%	N/A	N/A	N/A	N/A	N/A	N/A
19 Grahame Park	Ground	Living Room/R1	W1	36.60	33.18	-9.33%	-9.33%	99.00%	99.00%	0.00%	1.54%	1.40%	-8.81%	N/A	N/A	N/A	N/A	N/A	N/A
Way	First	Bedroom/R1	W1	37.65	34.16	-9.25%	-9.25%	98.49%	98.49%	0.00%	1.62%	1.47%	-8.91%	N/A	N/A	N/A	N/A	N/A	N/A
21 Grahame Park	Ground	Living Room/R1	W1	35.59	32.21	-9.49%	-9.49%	99.04%	99.04%	0.00%	1.50%	1.37%	-8.65%	N/A	N/A	N/A	N/A	N/A	N/A
Way	First	Bedroom/R1	W1	34.86	31.48	-9.70%	-9.70%	96.82%	96.82%	0.00%	1.44%	1.32%	-8.62%	N/A	N/A	N/A	N/A	N/A	N/A
23 Grahame Park	Ground	Living Room/R1	W1	36.46	33.17	-9.04%	-9.04%	99.00%	99.00%	0.00%	1.54%	1.40%	-8.53%	N/A	N/A	N/A	N/A	N/A	N/A
Way	First	Bedroom/R1	W1	37.68	34.32	-8.91%	-8.91%	98.70%	98.70%	0.00%	1.62%	1.48%	-8.57%	N/A	N/A	N/A	N/A	N/A	N/A
25 Grahame Park	Ground	Living Room/R1	W1	34.78	31.53	-9.34%	-9.34%	99.06%	99.06%	0.00%	1.47%	1.35%	-8.31%	N/A	N/A	N/A	N/A	N/A	N/A
Way	First	Bedroom/R1	W1	32.10	28.85	-10.11%	-10.11%	95.23%	95.23%	0.00%	1.34%	1.23%	-8.16%	N/A	N/A	N/A	N/A	N/A	N/A
27 Grahame Park	Ground	Living Room/R1	W1	36.59	33.45	-8.59%	-8.59%	99.17%	99.17%	0.00%	1.53%	1.41%	-8.13%	N/A	N/A	N/A	N/A	N/A	N/A
Way	First	Bedroom/R1	W1	37.69	34.46	-8.57%	-8.57%	98.63%	98.63%	0.00%	1.56%	1.43%	-8.29%	N/A	N/A	N/A	N/A	N/A	N/A
29 Grahame Park	Ground	Living Room/R1	W1	36.01	33.31	-7.49%	-7.49%	99.11%	99.11%	0.00%	1.51%	1.41%	-7.00%	N/A	N/A	N/A	N/A	N/A	N/A
Way	First	Bedroom/R1	W1	37.61	34.49	-8.30%	-8.30%	98.37%	98.37%	0.00%	1.56%	1.44%	-8.03%	N/A	N/A	N/A	N/A	N/A	N/A
31 Grahame Park	Ground	Living Room/R1	W1	35.37	32.40	-8.40%	-8.40%	99.00%	99.00%	0.00%	1.48%	1.37%	-7.66%	N/A	N/A	N/A	N/A	N/A	N/A
Way	First	Bedroom/R1	W1	37.49	34.44	-8.12%	-8.12%	98.65%	98.65%	0.00%	1.47%	1.35%	-7.83%	N/A	N/A	N/A	N/A	N/A	N/A
33 Grahame Park Way	First	Landing/R1	W1	37.79	35.06	-7.24%	-7.24%	97.44%	97.44%	0.00%	1.28%	1.19%	-7.06%	N/A	N/A	N/A	N/A	N/A	N/A

APPENDIX C

INTERNAL DAYLIGHT ADEQUACY TABLES

16336/LOC/850-855



DELVA PATMAN REDLER Chartered Surveyors

Dwg No	Address	Floor Level	Room Name	Window ID	ADF (Room) %age	Pass Rate %age	Condition
-			Bedroom/R1	W1	4.50%	1.00%	Pass
-			Bedroom/R2	W2	6.38%	1.00%	Pass
-			Bedroom/R3	W3	3.43%	1.00%	Pass
-			Bedroom/R4	W4	7.67%	1.00%	Pass
-				W5			
-			Bedroom/R5	W6	17.66%	1.00%	Pass
-				W7			
-			Bedroom/R6	W8	2.87%	1.00%	Pass
-				W9	_		
-			LKD/R7	W10	10.52%	1.50%	Pass
-				W11	_		
-		Ground		W12			
-			Bedroom/R8	W13	3.76%	1.00%	Pass
-			Living Room/R9	W14	4.71%	1.50%	Pass
-			Living Room/R10	W15	4.78%	1.50%	Pass
-			Bedroom/R11	W15	9.75%	1.00%	Pass
-				W16			
-			Bedroom/R12	W16	3.94%	1.00%	Pass
-			Living Room/R13	W17	3.89%	1.50%	Pass
-			Bedroom/R14	W18	2.80%	1.00%	Pass
-				W19			_
-			LKD/R15	W20	3.92%	1.50%	Pass
-				W21			
-			Bedroom/R1	W1	4.45%	1.00%	Pass
-			Bedroom/R2	W2	17.74%	1.00%	Pass
-	Block A			W3			
-			Bedroom/R3	W3	24.83%	1.00%	Pass
-				W4			
-			Bedroom/R4	W5	27.84%	1.00%	Pass
-				W6			
-				W7	_		
-			Bedroom/R5	W8 W9		1.00%	Pass
-			Bedroom/KS		20.97 %	1.00 %	Fass
-				W10	_		
-			Podroom/DC	W11	7.050/	1.00%	Dees
-			Bedroom/R6	W12 W13	7.85%	1.00%	Pass
-		First		W13 W14	-		
-			LKD/R7	W14 W15	11.16%	1.50%	Pass
-				W15			
-			Bedroom/R8	W18	7.02%	1.00%	Pass
-			Living Room/R9	W18	8.47%	1.50%	Pass
-			Bedroom/R10	W19	8.51%	1.00%	Pass
-				W19			
-			Bedroom/R11	W20	- 17.98%	1.00%	Pass
-			Bedroom/R12	W20	7.42%	1.00%	Pass
-			Living Room/R13	W21	6.99%	1.50%	Pass
-			Bedroom/R14	W22	5.27%	1.00%	Pass
-				W23			
-			LKD/R15	W24	6.02%	1.50%	Pass
-				W25	0.0270	1.0070	1 400
-			1	W26			

Dwg No	Address	Floor Level	Room Name	Window ID	ADF (Room) %age	Pass Rate %age	Condition
-			Living Room/R1	W1	0.05%	1.50%	Fail
-	-		Bedroom/R2	W2	0.00%	1.00%	Fail
-	-		Bedroom/R3	W3	1.73%	1.00%	Pass
-	-		Bedroom/R4	W3	1.46%	1.00%	Pass
-	-		Living Room/R5	W4	0.00%	1.50%	Fail
-	-		Bedroom/R6	W5	0.00%	1.00%	Fail
-	_		Bedroom/R7	W5	0.00%	1.00%	Fail
-	_		Living Room/R8	W6	0.96%	1.50%	Fail
-	-	Ground		W7			
-	-		LKD/R9	W8	2.29%	1.50%	Pass
-	_			W9			
-	_		Bedroom/R10	W10	7.43%	1.00%	Pass
-	-			W11			
-	-		Bedroom/R11	W12 W13	2.55%	1.00%	Pass
-	-		Bedroom/R12	W14	1.38%	1.00%	Pass
-	- -		Bedroom/R13	W15	2.32%	1.00%	Pass
-	Block B		Living Room/R1	W1	0.07%	1.50%	Fail
-	-		Bedroom/R2	W2	0.01%	1.00%	Fail
-	-		Living Room/R3	W3	0.46%	1.50%	Fail
-	-		Living Room/R4	W4	0.00%	1.50%	Fail
-			Bedroom/R5	W5	0.42%	1.00%	Fail
-			Bedroom/R6	W5	0.46%	1.00%	Fail
-	-		Living Room/R7	W6	0.00%	1.50%	Fail
-	-	First	Bedroom/R8	W7	0.38%	1.00%	Fail
-	-			W8			
-	-		LKD/R9	W9	2.30%	1.50%	Pass
-	-			W10	_		
-	-			W11			
-	-		Bedroom/R10	W12	7.46%	1.00%	Pass
-	-			W13			
-	-		Bedroom/R11	W14	2.58%	1.00%	Pass
_	-		Bedroom/R12	W15	1.40%	1.00%	Pass
_	-		Bedroom/R13	W16	2.33%	1.00%	Pass
-			Bedroom/R1	W1	3.54%	1.00%	Pass
_	-		Bedroom/R2	W2	1.66%	1.00%	Pass
-	-		Bedroom/R3	W3	1.73%	1.00%	Pass
-	-			W4			
-	-		Bedroom/R4	W5	4.43%	1.00%	Pass
-	-		Living Room/R5	W6	1.19%	1.50%	Fail
-	-		Bedroom/R6	W7	0.09%	1.00%	Fail
-	-	Ground	Bedroom/R7	W8	1.47%	1.00%	Pass
-	Block C		Living Room/R8	W8	1.10%	1.50%	Fail
-	Block C		Living Room/R9	W9	1.03%	1.50%	Fail
-			Bedroom/R10	W10	0.03%	1.00%	Fail
-			Bedroom/R11	W10	0.02%	1.00%	Fail
-			Bedroom/R12	W11	1.44%	1.00%	Pass
-	-		Living Room/R13	W12	1.63%	1.50%	Pass
-	-		Bedroom/R1	W1	3.54%	1.00%	Pass
-	-	First	Bedroom/R2	W2	1.66%	1.00%	Pass
-	-		Bedroom/R3	W3	1.73%	1.00%	Pass
		1					. 400

Dwg No	Address	Floor Level	Room Name	Window ID	ADF (Room) %age	Pass Rate %age	Condition
-		-	Bedroom/R4	W4	4.43%	1.00%	Pass
-				W5			
-			Living Room/R5	W6	0.02%	1.50%	Fail
-			Bedroom/R6	W7	0.08%	1.00%	Fail
-			Living Room/R7	W8	0.45%	1.50%	Fail
-	Block C	First	Living Room/R8	W9	0.01%	1.50%	Fail
-			Bedroom/R9	W10	0.49%	1.00%	Fail
-			Bedroom/R10	W10	0.54%	1.00%	Fail
-			Living Room/R11	W11	0.02%	1.50%	Fail
-			Bedroom/R12	W12	0.72%	1.00%	Fail
-			Living Room/R13	W13	0.12%	1.50%	Fail
-			Bedroom/R1	W1	1.12%	1.00%	Pass
-			Living Room/R2	W2	0.05%	1.50%	Fail
-			Living Room/R3	W3	0.03%	1.50%	Fail
-			Bedroom/R4	W4	0.07%	1.00%	Fail
-			Bedroom/R5	W4	0.06%	1.00%	Fail
-			Bedroom/R6	W5	0.94%	1.00%	Fail
-			Bedroom/R7	W6	4.79%	1.00%	Pass
-			Dedroom/rt/	W7	4.7370	1.0070	1 835
-			Bedroom/R8	W8	3.91%	1.00%	Pass
-			Living Room/R9	W9	2.29%	1.50%	Pass
-		Ground	Lining Deems (D40	W10	2.00%	4.50%	Deer
-			Living Room/R10	W11	3.68%	1.50%	Pass
-			Bedroom/R11	W12	1.87%	1.00%	Pass
-			Bedroom/R12	W13	1.55%	1.00%	Pass
-			Bedroom/R13	W14	1.65%	1.00%	Pass
-			Bedroom/R14	W15	5.52%	1.00%	Pass
-					W15		
-			Living Room/R15	W16	2.86%	1.50%	Pass
-				W17			
-			Living Room/R16	W18	0.90%	1.50%	Fail
-	Block D		Bedroom/R17	W19	1.43%	1.00%	Pass
-				W1			
_			Bedroom/R1	W32	0.87%	1.00%	Fail
-			Bedroom/R2	W2	2.01%	1.00%	Pass
-			Bedroom/R3	W3	2.04%	1.00%	Pass
-				W4			
-			Bedroom/R4	W5	0.59%	1.00%	Fail
-				W6			
-			Living Room/R5	W7	0.82%	1.50%	Fail
-			3	W8	-		
-			Bedroom/R6	W9	0.58%	1.00%	Fail
-		First	Living Room/R7	W10	2.28%	1.50%	Pass
-			Enting Room/RV	W10	2.2070	1.0070	1 000
-			Living Room/R8	W10	3.29%	1.50%	Pass
				W11			
•			Bedroom/R9		7.05%	1.00%	Pass
-			Badras /D40	W12	2.00%	1.00%	D
-			Bedroom/R10	W12	3.20%	1.00%	Pass
-			Bedroom/R11	W13	0.52%	1.00%	Fail
-			Bedroom/R12	W14 W15	4.83%	1.00%	Pass
-							

Dwg No	Address	Floor Level	Room Name	Window ID	ADF (Room) %age	Pass Rate %age	Condition
-			Living Room/R14	W17	2.31%	1.50%	Pass
-			Living Room/R15	W18	3.75%	1.50%	Pass
-			Living Room/RTS	W19	3.7370	1.50%	1 833
-			Bedroom/R16	W20	1.90%	1.00%	Pass
-			Bedroom/R17	W21	5.26%	1.00%	Pass
-			Bedroom/R18	W22	1.81%	1.00%	Pass
-			Bedroom/R19	W23	1.71%	1.00%	Pass
-	Block D	First		W24			
-			LKD/R20	W25	2.50%	1.50%	Pass
-				W26			
-			Living Room/R21	W27	1.13%	1.50%	Fail
-			Bedroom/R22	W28	1.45%	1.00%	Pass
-				W29			
-			Living Room/R23	W30	1.35%	1.50%	Fail
-				W31			
-			Bedroom/R1	W1	2.60%	1.00%	Pass
-			Bedroom/R2	W2	1.65%	1.00%	Pass
-			Bedroom/R3	W3	1.70%	1.00%	Pass
-			Bedroom/R4	W4	2.93%	1.00%	Pass
-			Living Room/R5	W5	1.89%	1.50%	Pass
-			Bedroom/R6	W6	0.05%	1.00%	Fail
-		Ground	Bedroom/R7	W7	1.54%	1.00%	Pass
-			Living Room/R8	W7	1.15%	1.50%	Fail
-			Living Room/R9	W8	1.16%	1.50%	Fail
-			Bedroom/R10	W9	0.07%	1.00%	Fail
-			Bedroom/R11	W9	0.06%	1.00%	Fail
-			Bedroom/R12	W10	1.77%	1.00%	Pass
-			Living Room/R13	W11	2.37%	1.50%	Pass
-	Block E		Bedroom/R1	W1	2.60%	1.00%	Pass
-			Bedroom/R2	W2	1.63%	1.00%	Pass
-			Bedroom/R3	W3	1.70%	1.00%	Pass
-			Bedroom/R4	W4	2.94%	1.00%	Pass
-			Living Room/R5	W5	0.11%	1.50%	Fail
-			Bedroom/R6	W6	0.05%	1.00%	Fail
-		First	Living Room/R7	W7	0.71%	1.50%	Fail
-			Living Room/R8	W8	0.05%	1.50%	Fail
-			Bedroom/R9	W9	1.13%	1.00%	Pass
-			Bedroom/R10	W9	1.23%	1.00%	Pass
-			Living Room/R11	W10	0.05%	1.50%	Fail
-			Bedroom/R12	W11	1.26%	1.00%	Pass
-			Living Room/R13	W12	0.57%	1.50%	Fail
-			Bedroom/R1	W1	1.13%	1.00%	Pass
-			Living Room/R2	W2	0.05%	1.50%	Fail
-			Living Room/R3	W3	0.04%	1.50%	Fail
-	Block F		Bedroom/R4	W4	0.08%	1.00%	Fail
-			Bedroom/R5	W4	0.07%	1.00%	Fail
-		Ground	Bedroom/R6	W5	0.94%	1.00%	Fail
-			D 1	W6		4.000	
-			Bedroom/R7	W7	4.78%	1.00%	Pass
			Bedroom/R8	W8	3.90%	1.00%	Pass
-		1			1		

Dwg No	Address	Floor Level	Room Name	Window ID	ADF (Room) %age	Pass Rate %age	Condition	
-			Living Room/R10	W10	3.69%	1.50%	Pass	
-			D (D11	W11	1.00%	4.00%		
-			Bedroom/R11	W12	1.88%	1.00%	Pass	
-			Bedroom/R12 Bedroom/R13	W13 W14	1.58%	1.00%	Pass	
-		Ground	Bedroom/R14	W14 W15	5.62%	1.00%	Pass	
-		oround	Bediooniii(114	W15	0.02 //	1.0070	1 455	
-			Living Room/R15	W16	2.90%	1.50%	Pass	
-			5	W17	_			
			Living Room/R16	W18	0.96%	1.50%	Fail	
-			Bedroom/R17	W19	1.55%	1.00%	Pass	
-				W1				
-			Bedroom/R1	W32	1.39%	1.00%	Pass	
-			Bedroom/R2	W2	2.61%	1.00%	Pass	
-			Bedroom/R3	W3	2.56%	1.00%	Pass	
-			Bedroom/R4	W4	0.27%	1.00%	Fail	
-			Bedroom/R4	W5	0.27%	1.00%	Fail	
-				W6				
-			Living Room/R5	W7	0.78%	1.50%	Fail	
-				W8				
-			Bedroom/R6	W9	0.57%	1.00%	Fail	
-	Block F		Living Room/R7	W10	2.18%	1.50%	Pass	
-			Living Room/R8	W10	3.18%	1.50%	Pass	
-				W11				
-		-		Bedroom/R9	W11	7.05%	1.00%	Pass
-				W12				
-			Bedroom/R10	W12	3.28%	1.00%	Pass	
-			Bedroom/R11	W13	0.54%	1.00%	Fail	
-		First	Bedroom/R12	W14	4.84%	1.00%	Pass	
-				W15			_	
-			Bedroom/R13	W16	3.96%	1.00%	Pass	
-			Living Room/R14	W17	2.30%	1.50%	Pass	
-			Living Room/R15	W18 W19	3.76%	1.50%	Pass	
-			Bedroom/R16	W20	1.91%	1.00%	Pass	
-			Bedroom/R17	W21	5.32%	1.00%	Pass	
-			Bedroom/R18	W22	1.84%	1.00%	Pass	
-			Bedroom/R19	W23	1.74%	1.00%	Pass	
-				W24	_		_	
-			LKD/R20	W25	2.56%	1.50%	Pass	
-				W26			-	
-			Living Room/R21	W27	1.21%	1.50%	Fail	
-			Bedroom/R22	W28	1.59%	1.00%	Pass	
-			Living Door (DOO	W29	1.50%	1 50%	D	
-			Living Room/R23	W30	1.53%	1.50%	Pass	
-			Bedroom/R1	W31	2 200/	1.00%	Paga	
-				W1	2.30%	1.00%	Pass	
-			Bedroom/R2	W2	2.50%	1.00%	Pass	
-	Block G	Ground	Living Room/R3	W3	1.41%	1.50%	Fail	
-			Bedroom/R4	W4	0.74%	1.00%	Fail	
-	1		Living Room/R5	W5	1.60%	1.50%	Pass	

Dwg No	Address	Floor Level	Room Name	Window ID	ADF (Room) %age	Pass Rate %age	Condition
-		Ground	Living Room/R7	W6	0.54%	1.50%	Fail
-		Giodila	Bedroom/R1	W1	2.30%	1.00%	Pass
_			Bedroom/R2	W2	2.50%	1.00%	Pass
-			Living Room/R3	W2 W3	0.94%	1.50%	Fail
-			Living Room/R4	W3 W4	0.73%	1.50%	Fail
-	Block G	First	Bedroom/R5	W5	1.56%	1.00%	Pass
-		Filst	Bedroom/R6	W5	1.83%	1.00%	Pass
-			Bedroom/R7				Pass
-			Bedroom/R8	W6 W6	1.03%	1.00%	Fail
				W7	0.88%	1.00%	
-			Living Room/R9 Bedroom/R1	W1	0.50%	1.50% 1.00%	Fail Pass
-					1.31%		
-			Living Room/R2	W2	0.15%	1.50%	Fail
-			Living Room/R3	W3	0.11%	1.50%	Fail
-			Bedroom/R4	W4	0.22%	1.00%	Fail
-			Bedroom/R5	W4	0.21%	1.00%	Fail
-		Orrest d	Bedroom/R6	W5	1.11%	1.00%	Pass
-		Ground	Bedroom/R7	W6	4.74%	1.00%	Pass
-				W7	0.000/	4.00%	
-			Bedroom/R8	W8	3.90%	1.00%	Pass
-			Living Room/R9	W9	2.65%	1.50%	Pass
-			Living Room/R10	W10	3.71%	1.50%	Pass
-	-			W11			
-			Bedroom/R11	W12	1.90%	1.00%	Pass
-			Bedroom/R1	W1	1.85%	1.00%	Pass
-		-		W32			
-			Bedroom/R2	W2	3.04%	1.00%	Pass
-			Bedroom/R3	W3	3.08%	1.00%	Pass
-			Bedroom/R4	W4	0.98%	1.00%	Fail
-				W5			
-				W6	-		
-	Block H		Living Room/R5	W7	0.85%	1.50%	Fail
-				W8			
-			Bedroom/R6	W9	0.73%	1.00%	Fail
-			Living Room/R7	W10	2.50%	1.50%	Pass
-			Living Room/R8	W11	1.86%	1.50%	Pass
-			Bedroom/R9	W11	8.01%	1.00%	Pass
-				W12			
-		First	Bedroom/R10	W12	3.72%	1.00%	Pass
-			Bedroom/R11	W13	0.68%	1.00%	Fail
-			Bedroom/R12	W14	4.80%	1.00%	Pass
-				W15			. 100
-			Bedroom/R13	W16	3.95%	1.00%	Pass
-			Living Room/R14	W17	2.68%	1.50%	Pass
-			Living Room/R15	W18	3.77%	1.50%	Pass
-			2	W19	5		. 355
-			Bedroom/R16	W20	1.92%	1.00%	Pass
-			Bedroom/R17	W21	5.38%	1.00%	Pass
-			Bedroom/R18	W22	1.88%	1.00%	Pass
-			Bedroom/R19	W23	1.81%	1.00%	Pass
-				W24			
-			LKD/R20	W25	2.51%	1.50%	Pass
_				W26	1		

Dwg No	Address	Floor Level	Room Name	Window ID	ADF (Room) %age	Pass Rate %age	Condition	
-	_		Living Room/R21	W27	1.50%	1.50%	Fail	
-			Bedroom/R22	W28	1.77%	1.00%	Pass	
-	Block H	First		W29				
-			Living Room/R23	W30	1.74%	1.50%	Pass	
-				W31				
-	_		Bedroom/R1	W1	2.85%	1.00%	Pass	
-	_		Bedroom/R2	W2	2.96%	1.00%	Pass	
-	_		LKD/R3	W3	0.28%	1.50%	Fail	
-	_			W4				
-	_		LKD/R4	W5	0.43%	1.50%	Fail	
-	_	Ground	Bedroom/R5	W6	1.30%	1.00%	Pass	
-	_			W7				
-	_			W8	4.470/	4.50%	5-3	
-	_		LKD/R6	W9	1.17%	1.50%	Fail	
-	-		Bedroom/R7	W10 W11	0.45%	1.00%	Fail	
-	-		Bedroom/R/ Bedroom/R1	W11 W1	2.73%	1.00%	Pass	
-	Block I		Bedroom/R1 Bedroom/R2	W1 W2	2.73%	1.00%	Pass	
-	DIOCK I		Deuroom/RZ	W2 W3	2.3070	1.00%	r 488	
			LKD/R3	W4	0.30%	1.50%	Fail	
				W5				
-	_		Living Room/R4	W6	1.22%	1.50%	Fail	
_			Living room/ref	W7	-	1.0070	i ui	
-		First		W8				
-	-		Bedroom/R5	W9	1.80%	1.00%	Pass	
-	-		Bedroom/R6	W10	2.84%	1.00%	Pass	
-				W11				
-				LKD/R7	W12	2.71%	1.50%	Pass
-				W13	-			
-			Bedroom/R8	W14	0.44%	1.00%	Fail	
-			Bedroom/R1	W1	2.58%	1.00%	Pass	
-	-		Bedroom/R2	W2	3.66%	1.00%	Pass	
-	-		Bedroom/R3	W3	2.92%	1.00%	Pass	
-	_			W4			_	
-	_		Bedroom/R4	W5	3.82%	1.00%	Pass	
-	1		Bedroom/R5	W6	2.53%	1.00%	Pass	
-	1		Bedroom/R6	W7	2.42%	1.00%	Pass	
-	1		Bedroom/R7	W8	1.60%	1.00%	Pass	
-	1		Bedroom/R8	W9	1.54%	1.00%	Pass	
-	1		LKD/R9	W10	0.79%	1.50%	Fail	
-	Block J	Ground		W11	0.7970	1.00%	Fall	
-	DIOCK J	Ground	Living Room/R10	W12	0.38%	1.50%	Fail	
-			Living Room/R11	W13	0.32%	1.50%	Fail	
-			Bedroom/R12	W14	1.57%	1.00%	Pass	
-			Living Room/R13	W15	0.01%	1.50%	Fail	
-			Bedroom/R14	W16	1.64%	1.00%	Pass	
-			Boaroomintia	W17	1.0470	1.0070	1 000	
-			Bedroom/R15	W18	0.00%	1.00%	Fail	
-			Bedroom/R16	W19	2.19%	1.00%	Pass	
-				W20				
-			LKD/R17	W21	0.31%	1.50%	Fail	
-	1		Bedroom/R18	W22	0.90%	1.00%	Fail	

Dwg No	Address	Floor Level	Room Name	Window ID	ADF (Room) %age	Pass Rate %age	Condition
-			Bedroom/R1	W1	2.50%	1.00%	Pass
-			Bedroom/R2	W2	3.66%	1.00%	Pass
-			Bedroom/R3	W3	2.92%	1.00%	Pass
-			Bedroom/R4	W4 W5	3.74%	1.00%	Pass
-			Bedroom/R5	W6	2.47%	1.00%	Pass
-			Bedroom/R6	W7	2.36%	1.00%	Pass
-			Bedroom/R7	W8	1.56%	1.00%	Pass
-			Bedroom/R8	W9	1.44%	1.00%	Pass
-				W10			
-			LKD/R9	W11	2.07%	1.50%	Pass
-			Living Room/R10	W12	3.53%	1.50%	Pass
-			Living Room/R11	W13	3.04%	1.50%	Pass
-	Block J	First	Bedroom/R12	W14	1.21%	1.00%	Pass
-				W15			
-			Living Room/R13	W16	0.21%	1.50%	Fail
-				W17			
-			Bedroom/R14	W18	1.71%	1.00%	Pass
-			Bedroom/R15	W19	3.40%	1.00%	Pass
-			Bedroom/R16	W20	3.42%	1.00%	Pass
-			Douloomintio	W21	0.12,0	1.0070	
-			Bedroom/R17	W22	2.40%	1.00%	Pass
-				W23			
-			Living Room/R18	W23	1.65%	1.50%	Pass
-		-	Living Room/RTO	W24 W25	1.0070	1.0070	1 455
			Living Room/R19	W26	0.89%	1.50%	Fail
-			Living Room/R1	W20	0.41%	1.50%	Fail
			Bedroom/R2	W2	2.65%	1.00%	Pass
			Dedroominte	W3	2.0070	1.0070	1 435
-			Living Room/R3	W4	5.41%	1.50%	Pass
			2.11.ing r toolin, r to	W5	-	1.0070	1 400
-			Bedroom/R4	W6	3.42%	1.00%	Pass
-			Bedroom/R5	W6	3.04%	1.00%	Pass
-			Boaroominto	W7	0.0170	1.0070	. 460
-			Living Room/R6	W8	6.00%	1.50%	Pass
				W9			. 100
-			Living Room/R7	W10	2.09%	1.50%	Pass
-				W10			. 100
-	Block K	First	Bedroom/R8	W12	5.44%	1.00%	Pass
-				W13	-		
-			Living Room/R9	W18	0.53%	1.50%	Fail
-				W15			
-			Bedroom/R10	W16	14.23%	1.00%	Pass
-				W10			
-			Bedroom/R11	W18	12.38%	1.00%	Pass
-				W19			. 100
-				W13			
-			Bedroom/R12	W20	12.83%	1.00%	Pass
-			Boardonintit	W21 W22			. 355
-			Bedroom/R13	W22 W23	8.39%	1.00%	Pass
-			Dealoomintio	W23	0.00 /0	1.0070	1 000
-	Block L	Ground	Bedroom/R1	W17	13.40%	1.00%	Pass
-				VV 17	l		

Dwg No	Address	Floor Level	Room Name	Window ID	ADF (Room) %age	Pass Rate %age	Condition
-	-			W2	12.87%		Pass
-			Bedroom/R2	W3		1.00%	
-			W4				
-				W5	-		_
-			Bedroom/R3	W6	12.85%	1.00%	Pass
-				W7			
-	-		Bedroom/R4	W8 W9	- 13.77%	1.00%	Pass
-		Cround	LKD/R5	W10	2.31%	1.50%	Pass
-		Ground	Living Room/R6	W11	2.60%	1.50%	Pass
-			Bedroom/R7	W12	4.83%	1.00%	Pass
-			Bedroom/R8	W12	5.69%	1.00%	Pass
-			Living Room/R9	W13	3.39%	1.50%	Pass
-			Bedroom/R10	W13	10.42%	1.00%	Pass
-			Dedroom/RT0	W14	10.4270	1.00 /0	Fass
-			Bedroom/R11	W14	3.70%	1.00%	Pass
-			Bedroom/R12	W15	3.88%	1.00%	Pass
-			LKD/R13	W16	2.27%	1.50%	Pass
-	Block L		Podroom/D1	W1	12 60%	1.00%	Pass
-			Bedroom/R1	W18	- 13.69%		
			Bedroom/R2	W2	12.88%		
				W3			
-	-			W4			
-				W5			
-	-		Bedroom/R3	W6	12.87%	1.00%	Pass
-				W7			
-	-			W8		1.000/	_
-	-	First	Bedroom/R4	W9	13.84%	1.00%	Pass
-			Living Room/R5	W10	0.43%	1.50%	Fail
			Bedroom/R6	W11	2.69%	1.00%	Pass
-			Living Room/R7	W12	2.63%	1.50%	Pass
			Living Room/R8	W13	2.34%	1.50%	Pass
-	Block M		Bedroom/R9	W14	3.89%	1.00%	Pass
-			Bedroom/R10	W14	4.22%	1.00%	Pass
-			Living Room/R11	W15	2.04%	1.50%	Pass
-			Bedroom/R12	W16	2.75%	1.00%	Pass
-			Living Room/R13	W17	0.78%	1.50%	Fail
-			Bedroom/R1	W1	1.88%	1.00%	Pass
-			Living Room/R2	W2	1.24%	1.50%	Fail
-			Bedroom/R3	W3	0.54%	1.00%	Fail
-			Living Room/R4	W4	0.30%	1.50%	Fail
-			Living Room/R5	W5	0.37%	1.50%	Fail
-			Bedroom/R6	W6	1.09%	1.00%	Pass
-			Bedroom/R7	W7	2.21%	1.00%	Pass
-		Ground		W8			
-			Living Room/R8	W9	4.03%	1.50%	Pass
-		- -	Living Room/R9	W10	3.96%	1.50%	Pass
-			Bedroom/R10	W11	2.89%	1.00%	Pass
_			Bedroom/R11	W12	2.89%	1.00%	Pass
-	4			W13			
-			Bedroom/R12	W14	4.56%	1.00%	Pass
	{		Bearoom/R12	W15	4.56%	1.00%	Pass

Dwg No	Address	Floor Level	Room Name	Window ID	ADF (Room) %age	Pass Rate %age	Condition
-	-	Ground	Bedroom/R13	W16	0.97%	1.00%	Fail
-			Bedroom/R1	W1	1.38%	1.00%	Pass
-			Living Room/R2	W2	0.97%	1.50%	Fail
-			Living Beem/D2	W3	5 019/	1 50%	Daga
-			Living Room/R3	W4	5.21%	1.50%	Pass
-			Bedroom/R4	W4	0.40%	1.00%	Daga
-			Bedroom/R4	W5	9.40%	1.00%	Pass Pass Pass Pass Pass Pass Pass Pass
-			Living Room/R5	W5	3.25%	1.50%	Pass
-			Bedroom/R6	W6	1.19%	1.00%	Pass
-				W7			
-			Living Room/R7	W8	1.10%	1.50%	Fail
-				W9			
-			D 1 (D)	W10	1.35%	1.000/	5
-			Bedroom/R8	W11		1.00%	Pass
-			Bedroom/R9	W12	3.06%	1.00%	Pass
-	Block M	E	Bedroom/R10	W13	3.00%	1.00%	Pass
-		First	De las (D11	W14	4.0101	4.000	D.
-			Bedroom/R11	W15	1.21%	1.00%	Pass
-				W16	1.31%	1.50%	Fail
-			Living Room/R12	W17			
-				W18			
-	-		Bedroom/R19	W19	2.24%	1.00%	Pass
-			Living Room/R20	W20			_
-	-			W21	4.08%	1.50%	Pass
-	-		Living Room/R21	W22	3.98%	1.50%	Pass
-	-		Bedroom/R22	W23	2.92%	1.00%	Pass
-	-		Bedroom/R23	W24	2.93%	1.00%	Pass
-	-		Bedroom/R24	W25	4.63%	1.00%	
-				W26			
-				W27			
-			Bedroom/R25	W28	0.99%	1.00%	Fail
-			Bedroom/R1	W1	2.93%	1.00%	Pass
-			Bedroom/R2	W2	3.57%	1.00%	Pass
-			Bedroom/R3	W3	2.73%	1.00%	Pass
-	Block N		Living Room/R4	W4	0.94%	1.50%	Fail
-			Living Room/R5	W5	0.25%	1.50%	Fail
-		Ground		W6			
-			Bedroom/R6	W7	1.59%	1.00%	Pass
-			Bedroom/R7	W8	0.00%	1.00%	Fail
-			Bedroom/R8	W9		1.00%	Pass
-				W10	2.48%		
-			Living Room/R9	W11	0.31%	1.50%	Fail
-			Bedroom/R1	W1	3.00%	1.00%	Pass
-			Bedroom/R2	W2	3.57%	1.00%	Pass
-			Bedroom/R3	W3	2.64%	1.00%	Pass
-			Living Room/R4	W4	0.81%	1.50%	Fail
-				W5		-	
-		First	Living Room/R5	W6	1.35%	1.50%	Fail
-				W7			
-				W8			
-			Bedroom/R6	W9	1.98%	1.00%	Pass
-	-		Bedroom/R7	W9 W10	3.54%	1.00%	Pass
-			Douroon/IN/	WIG	J.JT /U	1.0070	1 000


Dwg No	Address	Floor Level	Room Name	Window ID	ADF (Room) %age	Pass Rate %age	Condition
-			Bedroom/R8	W11	3.57%	1.00%	Pass
-	Block N	First	Bedroom/R9	W12	2.59%	1.00%	Pass
-	DIOORTI	11130	Bedroominto	W13	2.0070	1.0070	rass
-			Living Room/R10	W14	0.29%	1.50%	Fail
-		Ground	Bedroom/R1	W1	2.76%	1.00%	Pass
-			Bedroom/R2	W2	2.70%	1.00%	Pass
-			Bedroom/R3	W3	1.44%	1.00%	Pass
-			Bedroom/R4	W4	1.56%	1.00%	Pass
-			Bedroom/R5	W5	2.35%	1.00%	Pass
-			Bedroom/R6	W6	2.46%	1.00%	Pass
-			Bedroom/R7	W7	1.87%	1.00%	Pass
-			Bedroom/R8	W8	1.69%	1.00%	Pass
-			Living Room/R9	W9	0.42%	1.50%	Fail
-			LKD/R10	W10	0.38%	1.50%	Fail
-	1			W11			
-	1		LKD/R11	W12	- 0.87%	1.50%	Fail
-	1		Bedroom/R12	W13	0.49%	1.00%	Fail
-	-			W14			
-			Living Room/R13	W15	0.82%	1.50%	Fail
-			Bedroom/R14	W16	2.95%	1.00%	Pass
-				W17			
-			Bedroom/R15	W18	0.56%	1.00%	Fail
-			Living Room/R16	W19	0.25%	1.50%	Fail
-			Bedroom/R1	W19 W1	2.76%	1.00%	Pass
-			Bedroom/R2	W2	2.70%	1.00%	Pass
-	Block O		Bedroom/R3	W2 W3	1.44%		Pass
	-					1.00%	
-			Bedroom/R4	W4	1.56%	1.00%	Pass
-	-		Bedroom/R5	W5	2.35%	1.00%	Pass
-	-		Bedroom/R6	W6	2.46%	1.00%	Pass
-	-		Bedroom/R7	W7	3.85%	1.00%	Pass
-	-			W8			
-	-		Bedroom/R8	W9	1.32%	1.00%	Pass
-			Living Room/R9	W10	3.24%	1.50%	Pass
-			Living Room/R10	W11	2.98%	1.50%	Pass
-			LKD/R11	W12	2.23%	1.50%	Pass
-	Block P			W13			
-			Bedroom/R12	W14	0.49%	1.00%	Fail
-			Living Room/R13	W15	4.45%	1.50%	Pass
-				W16			
-				W17			
-			Bedroom/R14	W18	3.59%	1.00%	Pass
-			Bedroom/R15	W19	2.99%	1.00%	Pass
-				W20	2.3370	1.0070	1-922
-			Living Room/R16	W21	- 1.29%	1.50%	Fail
-				W22			
-			Living Room/R17	W23	0.32%	1.50%	Fail
-			Living Room/R1	W1			
-				W2	0.82%	1.50%	Fail
-		Orecard		W3	1		
-		Ground	Bedroom/R2	W4	0.000		
-				W5	3.30%	1.00%	Pass
_			Bedroom/R3	W6	1.99%	1.00%	Pass

Dwg No	Address	Floor Level	Room Name	Window ID	ADF (Room) %age	Pass Rate %age	Condition	
-				W7				
-		Ground	LKD/R4	W8	4.03%	1.50%	Pass	
-		Giodila		W9				
-			Bedroom/R5	W10	2.63%	1.00%	Pass	
-				W1				
-				W2				
-			LKD/R1 W3 7.10% W26 W27	7.10%	1.50%	Pass		
-				W26	_			
-				W27				
-			Living Room/R2	W4	3.13%	1.50%	Pass	
-			Bedroom/R3	W5	2.20%	1.00%	Pass	
-			Bedroom/R4	W6	2.59%	1.00%	Pass	
-			Bedroom/R5	W7	4.70%	1.00%	Pass	
-				W8				
-			-	W9	_			
-	Block P		LKD/R6	W10	0.56%	1.50%	Fail	
-				W11				
-		First		W12			Fail	
-			Living Room/R7	W13	0.57%	1.50%		
-				W14				
-			Bedroom/R8	W15	2.36%	1.00%	Pass	
-			W16			-		
-			Bedroom/R9	W17	2.04%	1.00%	Pass	
-				W18	4.440/	4.50%	Deer	
-			LKD/R10	W19	4.14% 1.50%	1.50%	Pass	
-			D. I. (D.()	W20	0.740/	1.00%		
-			Bedroom/R11 Bedroom/R12	W21 W22	2.71%	1.00%	Pass	
-			Bedroom/R12	W22 W23	1.47%			
-			Bedroom/R13	W23 W24	6.74%	1.00%	Pass	
-			Bedroom/R14	W24 W25				
-			Bedroom/R1	W23	5.47%	1.00%	Pass	
-	-			W13				
-			Bedroom/R2	W10	1.73%	1.00%	Pass	
-			Bedroom/R3	W3	1.73%	1.00%	Pass	
-				W4			1 400	
_	Block Q		Bedroom/R4	W5	5.35%	1.00%	Pass	
-			Living Room/R5	W6	1.65%	1.50%	Pass	
-		Ground	Bedroom/R6	W7	0.98%	1.00%	Fail	
-			Bedroom/R7	W8	2.62%	1.00%	Pass	
-			Living Room/R8	W8	2.02%	1.50%	Pass	
-			Living Room/R9	W9	1.96%	1.50%	Pass	
-			Bedroom/R10	W10	1.39%	1.00%	Pass	
-			Bedroom/R11	W10	1.21%	1.00%	Pass	
-			Bedroom/R12 W11 2.25%	1.00%	Pass			
-				Living Room/R13	W12	2.07%	1.50%	Pass
-			Dedre /D4	W1	E 400/	1.00%	Derr	
-			Bedroom/R1	W14	5.48%	1.00%	Pass	
-		Eine A	Bedroom/R2	W2	1.71%	1.00%	Pass	
-		First	Bedroom/R3	W3	1.71%	1.00%	Pass	
-			Dut Ti	W4	5.05%	4.000/	2	
-			Bedroom/R4	W5	5.35%	1.00%	Pass	

Dwg No	Address	Floor Level	Room Name	Window ID	ADF (Room) %age	Pass Rate %age	Condition
-			Living Room/R5	W6	1.53%	1.50%	Pass
-			Bedroom/R6	W7	0.95%	1.00%	Fail
-			Living Room/R7	W8	1.88%	1.50%	Pass
-			Living Room/R8	W9	0.92%	1.50%	Fail
-	Block Q	First	Bedroom/R9	W10	2.84%	1.00%	Pass
-			Bedroom/R10	W10	3.08%	1.00%	Pass
-	-		Living Room/R11	W11	0.84%	1.50%	Fail
-	-		Bedroom/R12	W12	2.00%	1.00%	Pass
-	_		Living Room/R13	W13	1.89%	1.50%	Pass
-			Bedroom/R1	W1	5.44%	1.00%	Pass
	_		Bedroom/R2	W2	4.66%	1.00%	Pass
-			Bedroom/R3	W3	4.52%	1.00%	Pass
-	-		Bedroom/R4	W4	3.08%	1.00%	Pass
-	-		Bedroom/R5	W5	3.55%	1.00%	Pass
-	_		Bedroom/R6	W6	1.69%	1.00%	Pass
-			Living Room/R7	W7	0.98%	1.50%	Fail
-	_		Living Room/R8	W8	0.41%	1.50%	Fail
	_		2.mig roomroo	W9	0.1170	1.00 / 0	
	_	Ground	Bedroom/R9	W10	3.91%	1.00%	Pass
-			Bedroom/R10	W10	0.80%	1.00%	Fail
-	_		Bediooni/KTO		0.80 %	1.00 %	Fall
	_		Bedroom/R11	W12	4.37%	1.00%	Pass
-	_			W13			
-	_	First	Living Room/R12	W14	0.78%	1.50%	Fail
-			Bedroom/R13	W15	3.13%	1.00%	Pass
-	_		Living Room/R14	W16	1.44%	1.50%	Fail
-	_		LKD/R15	W17	4.25%	1.50%	Pass
-	_			W18			
-	Block R		Bedroom/R1	W1	5.21%	1.00%	Pass
-	_		Bedroom/R2	W2	4.55%	1.00%	Pass
-			Bedroom/R3	W3	4.39%	1.00%	Pass
-			Bedroom/R4	W4	3.08%	1.00%	Pass
-			Bedroom/R5	W5	3.55%	1.00%	Pass
-			Bedroom/R6	W6	1.56%	1.00%	Pass
-			Living Room/R7	W7	0.96%	1.50%	Fail
-	1		Lisian Daram (DO	W8	0.000/	4.50%	5 -3
-			Living Room/R8	W9	- 0.86%	1.50%	Fail
-			De des (DC	W10	0.45%	1.00%	Pass
-			Bedroom/R9	W11	- 3.45%		
-			Bedroom/R10	W12	5.04%	1.00%	Pass
-			Bedroom/R11	W13	5.09%	1.00%	Pass
-				W14			
-			Bedroom/R12	W15	4.44%	1.00%	Pass
-			Living Room/R13	W16	0.84%	1.50%	Fail
			Bedroom/R14	W10	3.24%	1.00%	Pass
-			Living Room/R15	W18	1.26%	1.50%	Fail
-				W18	1.2070	1.00 /0	1 40
-			LKD/R16	W19 W20	4.12%	1.50%	Pass


|--|

low ID	ADF (Room) %age	Pass Rate %age	Condition

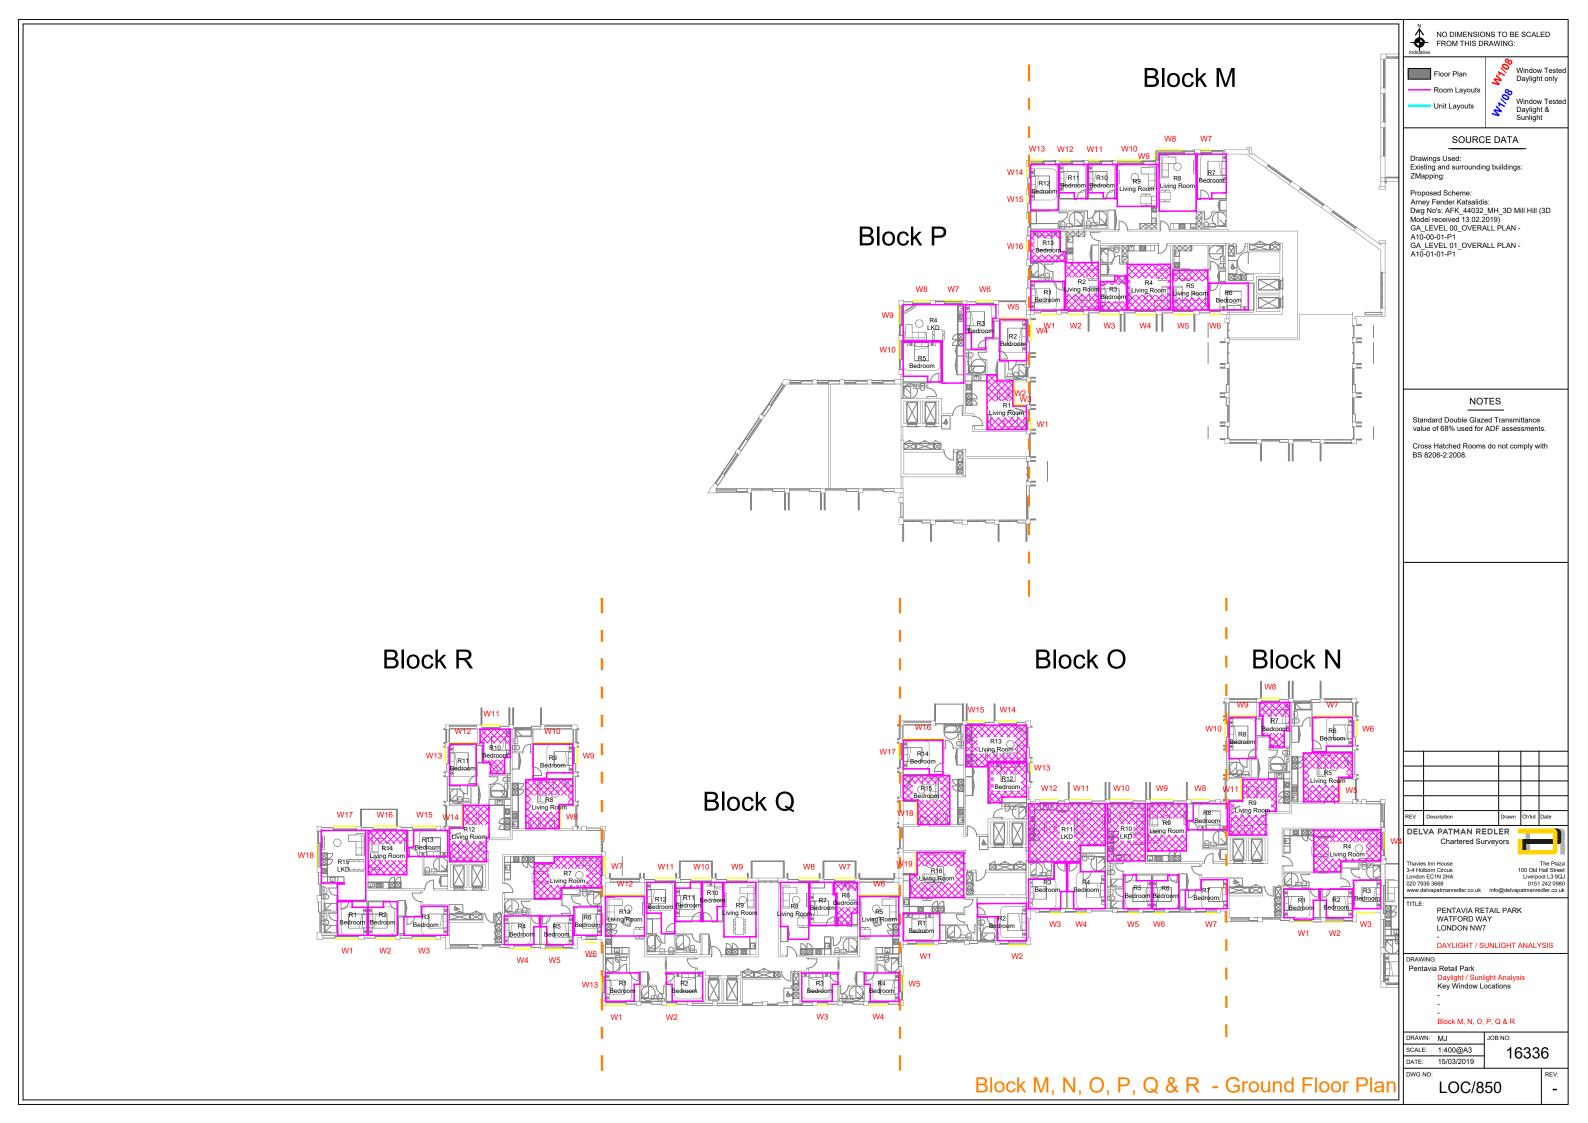




	1		
	NO DIMENSIO FROM THIS D	NS TO BE SCAL RAWING:	ED
	Floor Plan Room Layouts	Window Dayligh	Tested t only
	Unit Layouts	Window Dayligh Sunligh	Tested
	SOURC	E DATA	
	Existing and surroundir ZMapping: Proposed Scheme:	ng buildings:	
	Arrey Fender Katsalid Dwg No's: AFK_44032 Model received 13.02.2 GA_LEVEL 00_OVER/ A10-00-01-P1 GA_LEVEL 01_OVER/ A10-01-01-P1	_MH_3D Mill Hill (019) ALL PLAN -	3D
	NO Standard Double Glaz	TES ed Transmittance	
	value of 68% used for Cross Hatched Rooms BS 8206-2:2008.		
	REV Description DELVA PATMAN RE Chartered Su		Date
	Thavies Inn House 3-4 Holborn Circus London EC1N 2HA	100 Old H Liverpo	The Plaza Iall Street ol L3 9QJ
	020 7936 3668 www.delvapatmanredler.co.uk TITLE: PENTAVIA RE	info@delvapatmanre	242 0980 dler.co.uk
	WATFORD WA LONDON NW7 - DAYLIGHT / S		SIS
	DRAWING: Pentavia Retail Park Daylight / Sunl Key Window L		
	- Block F, G, H,		
	DRAWN: MJ SCALE: 1:400@A3 DATE: 15/03/2019	JOB NO: 1633	
- Ground Floor Plan	DWG NO: LOC/8	51	REV:

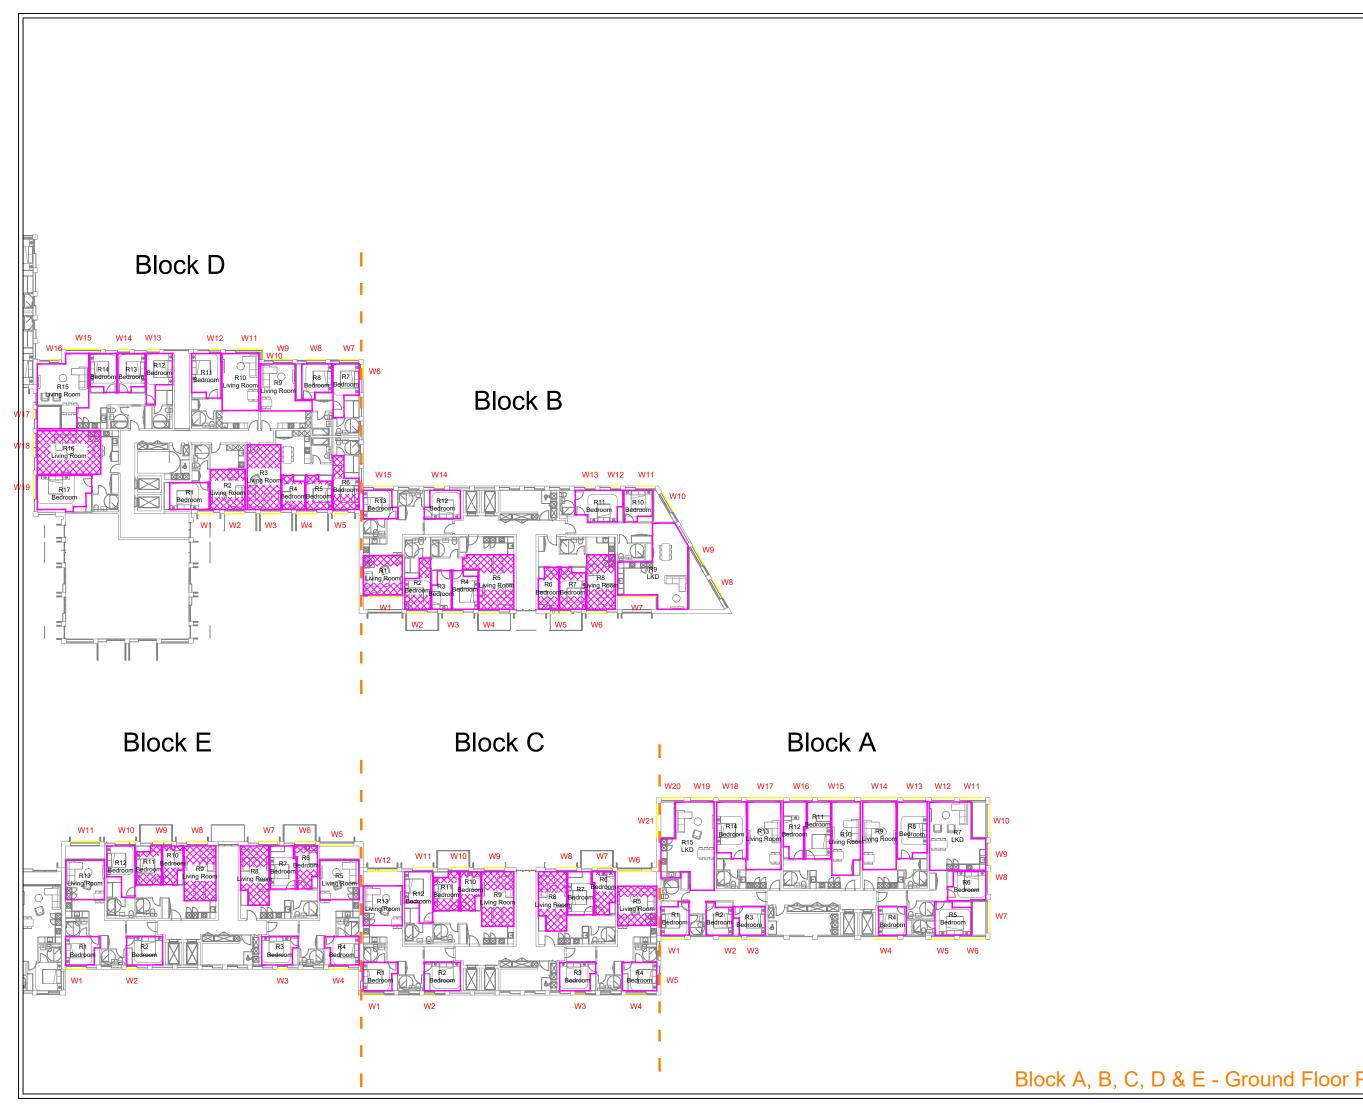


	NO DIMENSIONS TO BE SCALED FROM THIS DRAWING:
	Floor Plan Room Layouts
	Unit Layouts Unit Cayout & Window Tested Daylight & Sunlight
	SOURCE DATA
	Drawings Used: Existing and surrounding buildings: ZMapping:
	Proposed Scheme: Arney Fender Katsalidis:
	Model received 13.02.2019) GA_LEVEL 00_OVERALL PLAN -
	A10-00-01-P1 GA_LEVEL 01_OVERALL PLAN - A10-01-01-P1
	NOTES
	Standard Double Glazed Transmittance
	value of 68% used for ADF assessments. Cross Hatched Rooms do not comply with
	BS 8206-2:2008.
	REV Description Drawn Ch'kd Date
	DELVA PATMAN REDLER
	Chartered Surveyors
	3-4 Holborn Circus 100 Old Hall Street London EC1N 2HA Liverpool L3 9QJ 020 7936 3668 0151 242 0980
	www.delvapatmanredler.co.uk info@delvapatmanredler.co.uk TITLE: PENTAVIA RETAIL PARK
	WATFORD WAY LONDON NW7
	DAYLIGHT / SUNLIGHT ANALYSIS
	Pentavia Retail Park Daylight / Sunlight Analysis Key Window Locations
	Block A, B, C, D & E
	DRAWN: MJ JOB NO: SCALE: 1:400@A3 DATE: 15/03/2019
Dlan	DWG NO: REV:
	LOC/852 -

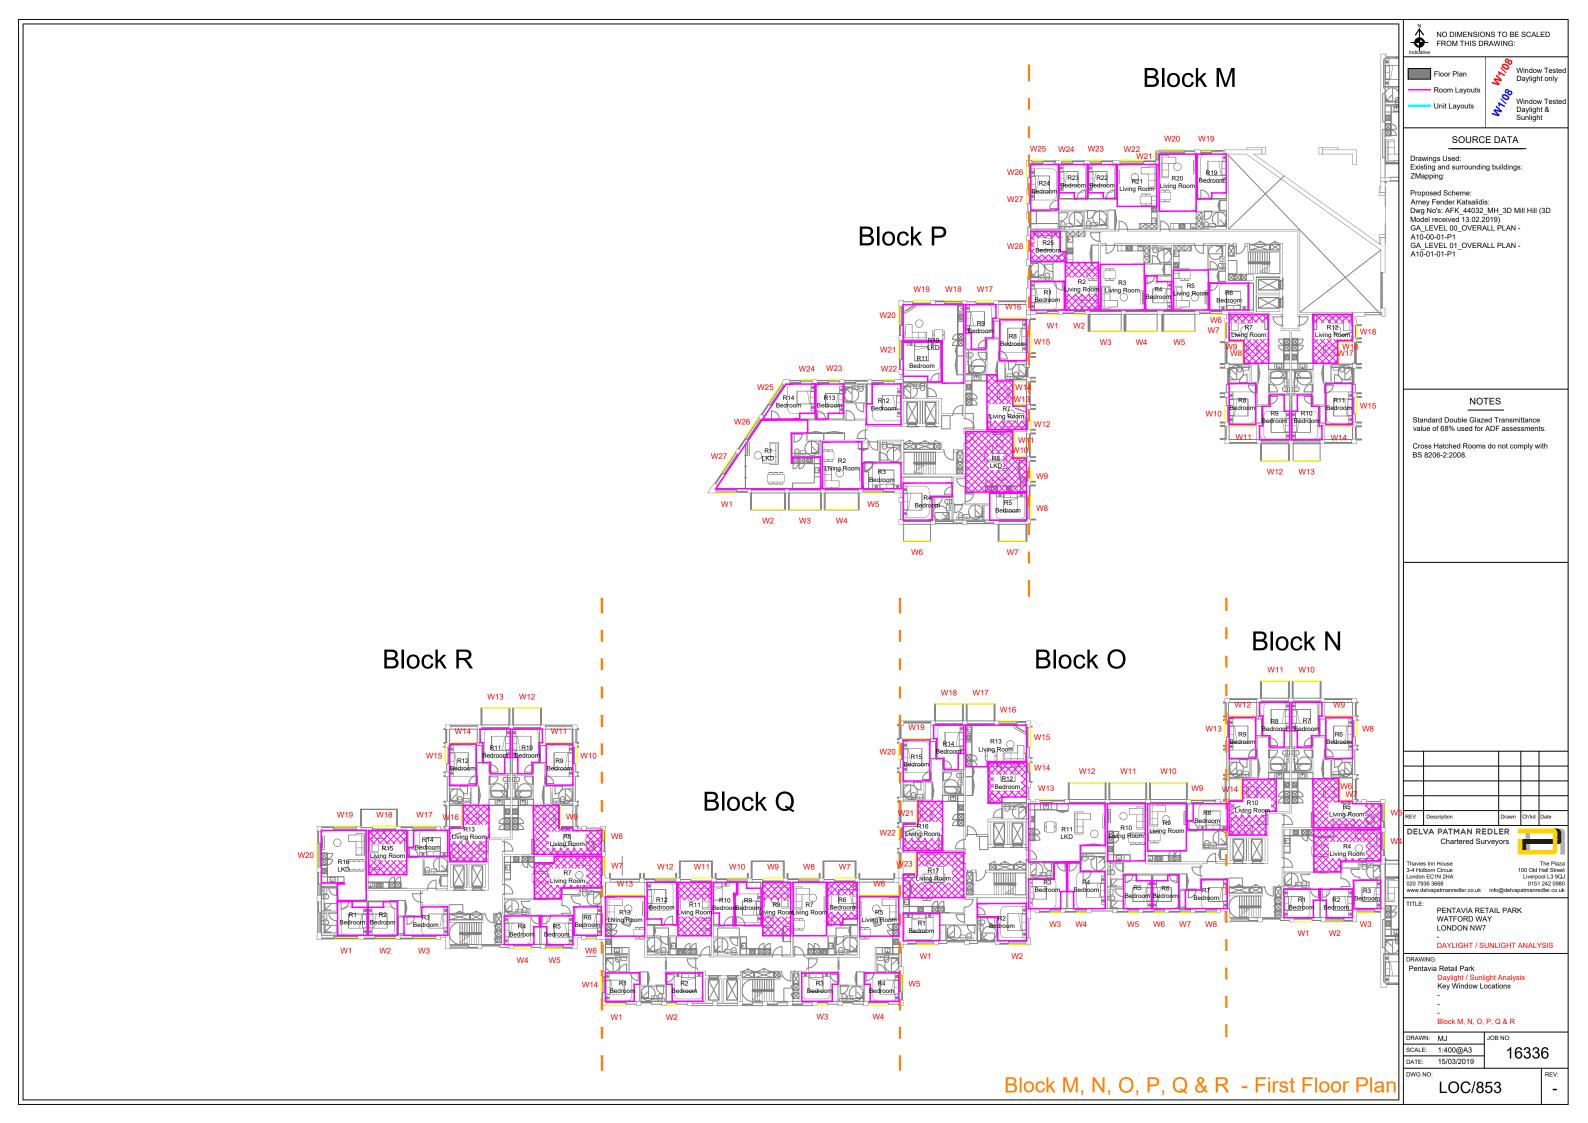



	NO DIMENSIONS TO BE SCALED FROM THIS DRAWING:	
	Floor Plan Room Layouts	
	Unit Layouts Window Te Daylight & Sunlight	sted
	SOURCE DATA Drawings Used: Existing and surrounding buildings:	
	ZMapping: Proposed Scheme: Arney Fender Katsalidis:	
	Miney Periodi Activation Dwg Nos: AFK_44032_MH_3D Mill Hill (3D Model received 13.02.2019) GA_LEVEL 00_OVERALL PLAN - A10-00-01-P1 GA_LEVEL 01_OVERALL PLAN - A10-01-01-P1	
	NOTES Standard Double Glazed Transmittance	
	value of 68% used for ADF assessments. Cross Hatched Rooms do not comply with BS 8206-2:2008.	
	REV Description Drawn Ch'kd Date	_
	DELVA PATMAN REDLER Chartered Surveyors	
	Thavies Inn House The f 3-4 Holborn Circus 100 Old Hall S London EC1N 2HA Liverpool L 020 7936 3668 0151 242 www.delvapatmanredier.co.uk info@delvapatmanredier.	treet 9QJ 0980
	TITLE: PENTAVIA RETAIL PARK WATFORD WAY LONDON NW7	_
	- DAYLIGHT / SUNLIGHT ANALYSIS DRAWING:	,
	Pentavia Retail Park Daylight / Sunlight Analysis Key Window Locations - -	
	Block F, G, H, I, J, K & L	
	SCALE: 1:400@A3 DATE: 1:5/03/2019 DWG NO: RE	v.
L - First Floor Plan		-

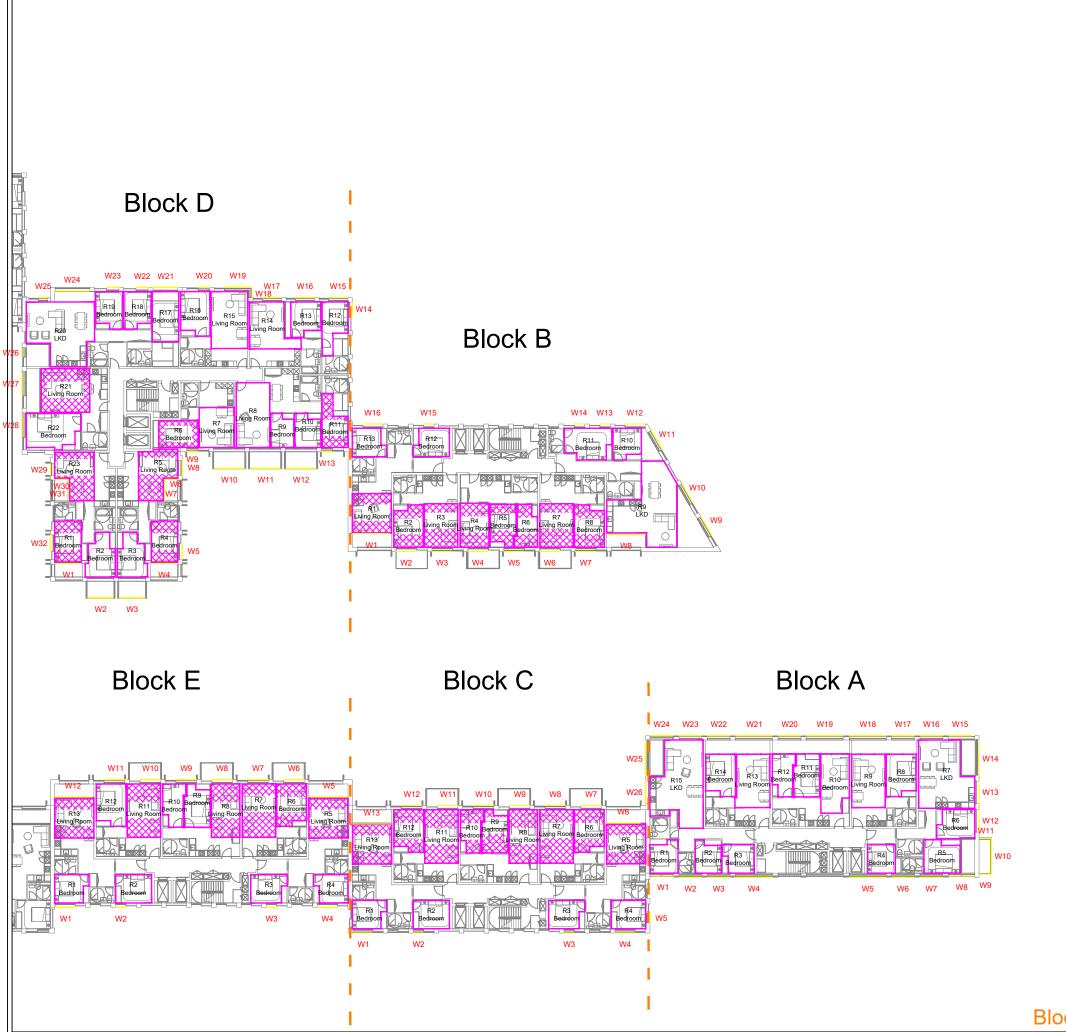

Block A, B, C, D & E - First Floor F

1	N
	NO DIMENSIONS TO BE SCALED FROM THIS DRAWING:
	Floor Plan
	Com Layouts Vindow Tested Daylight & Sunlight
	SOURCE DATA
	Drawings Used: Existing and surrounding buildings:
	ZMapping: Proposed Scheme:
	Arney Fender Katsalidis: Dwg No's: AFK_44032_MH_3D Mill Hill (3D Model received 13.02.2019)
	GA_LEVEL 00_OVERALL PLAN - A10-00-01-P1 GA_LEVEL 01_OVERALL PLAN -
	A10-01-01-P1
	NOTES Standard Double Glazed Transmittance
	value of 68% used for ADF assessments.
	Cross Hatched Rooms do not comply with BS 8206-2:2008.
	REV Description Drawn Ch'kd Date
	Chartered Surveyors
	Thavies Inn House The Plaza 3-4 Holborn Circus 100 Old Hall Street London EC1N 2HA Liverpool L3 9QJ
	020 7936 3668 0151 242 0980 www.delvapatmanredler.co.uk info@delvapatmanredler.co.uk TITLE:
	PENTAVIA RETAIL PARK WATFORD WAY LONDON NW7
	- DAYLIGHT / SUNLIGHT ANALYSIS
	DRAWING: Pentavia Retail Park Daylight / Sunlight Analysis
	Key Window Locations
	- - Block A, B, C, D & E
	DRAWN: MJ JOB NO:
	DATE: 15/03/2019
Plan	LOC/855 REV:
	I


APPENDIX D

OVERSHADOWING ANALYSIS


16336/SHD/523-529






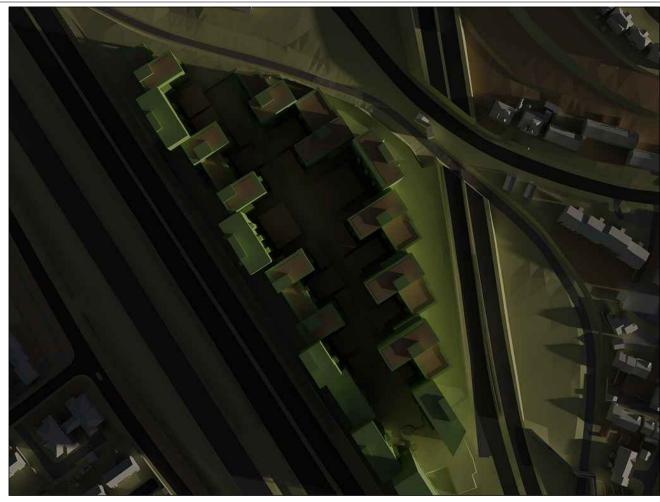


0700hrs March 21st Proposed - Plan

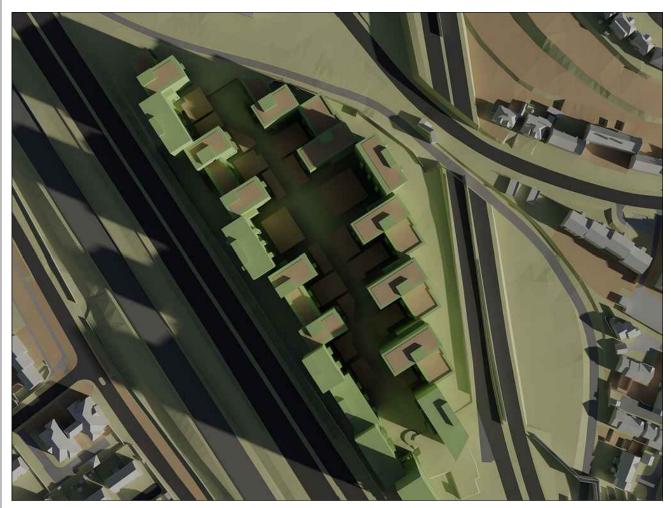


0800hrs March 21st Proposed - Plan

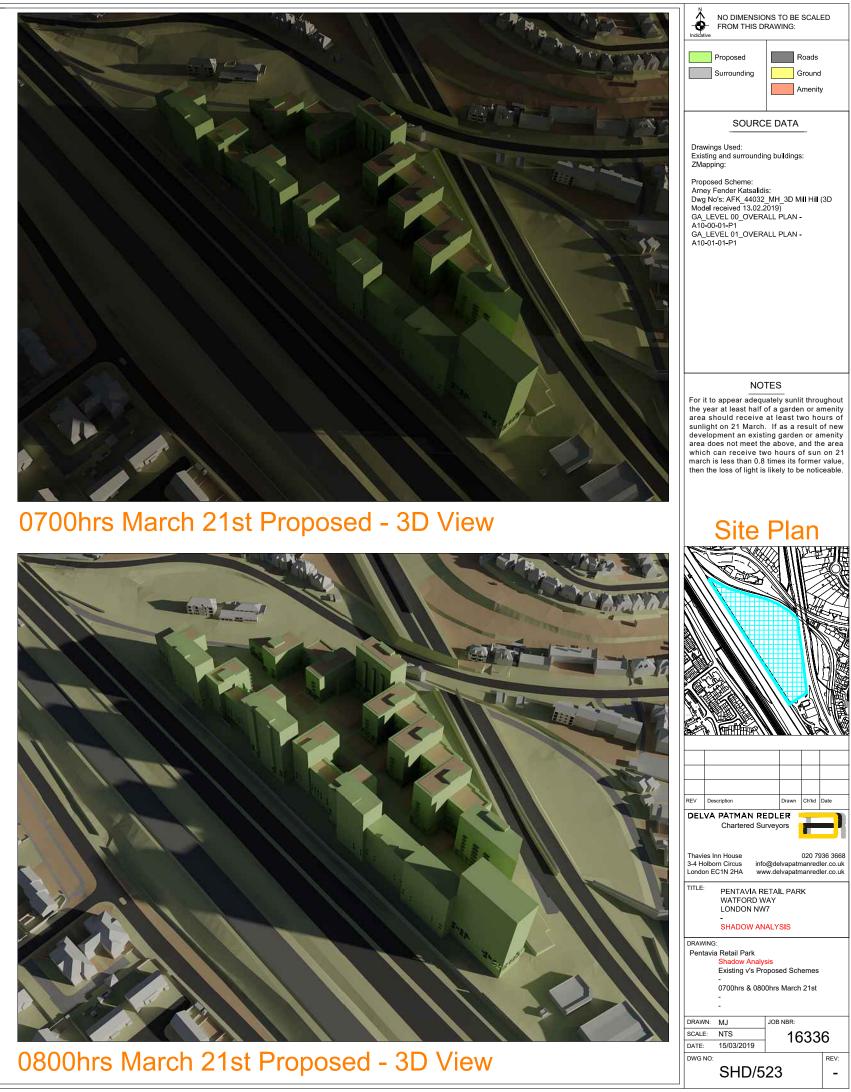



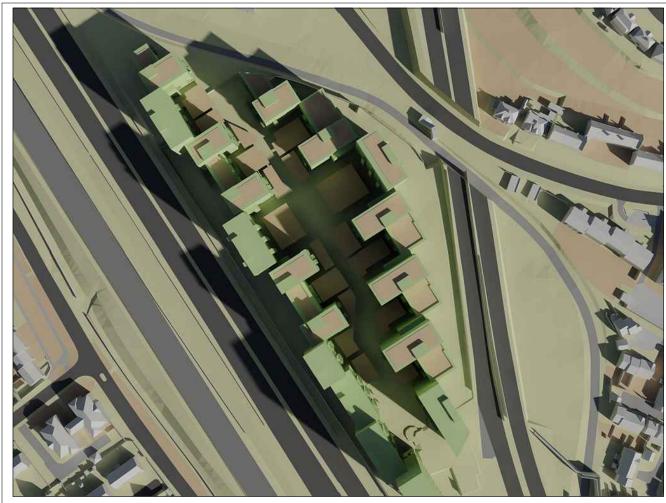


0900hrs March 21st Proposed - Plan

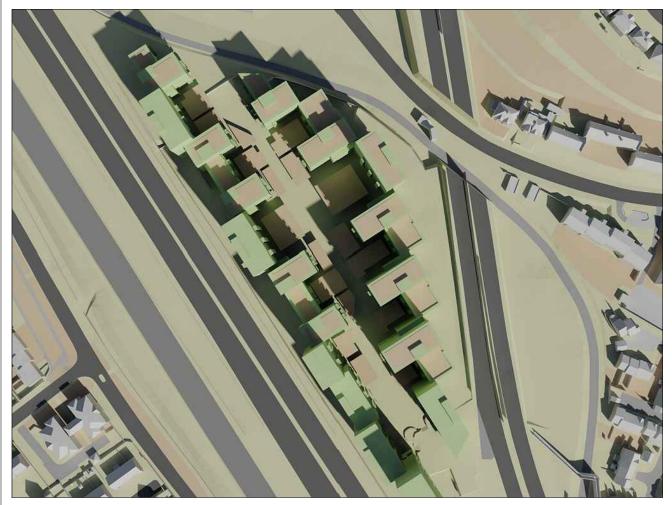


1000hrs March 21st Proposed - Plan






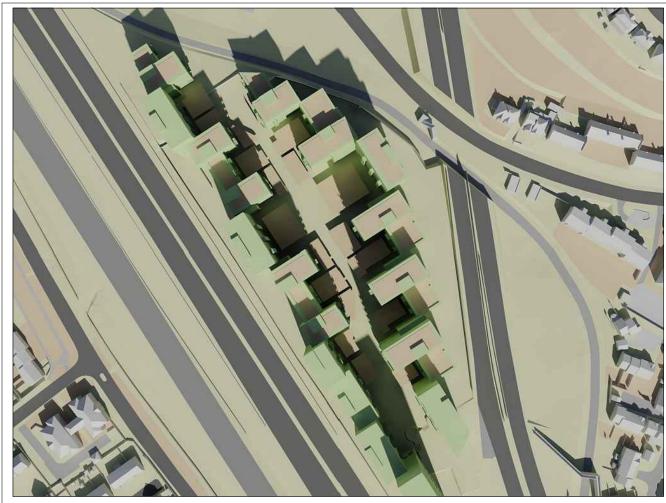



1100hrs March 21st Proposed - Plan

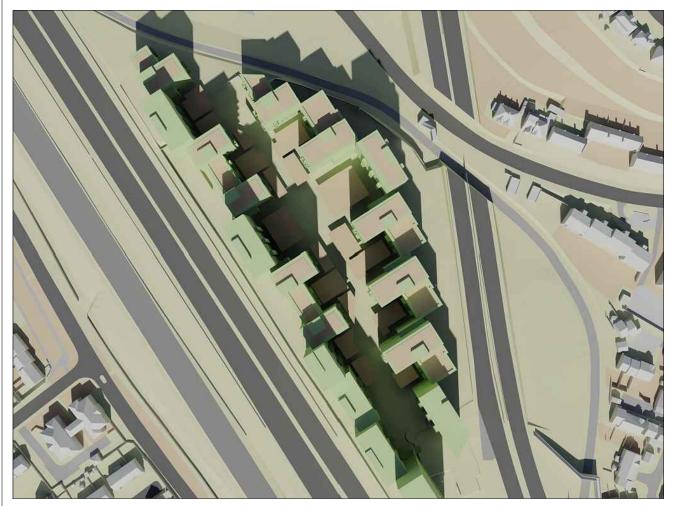

1200hrs March 21st Proposed - Plan

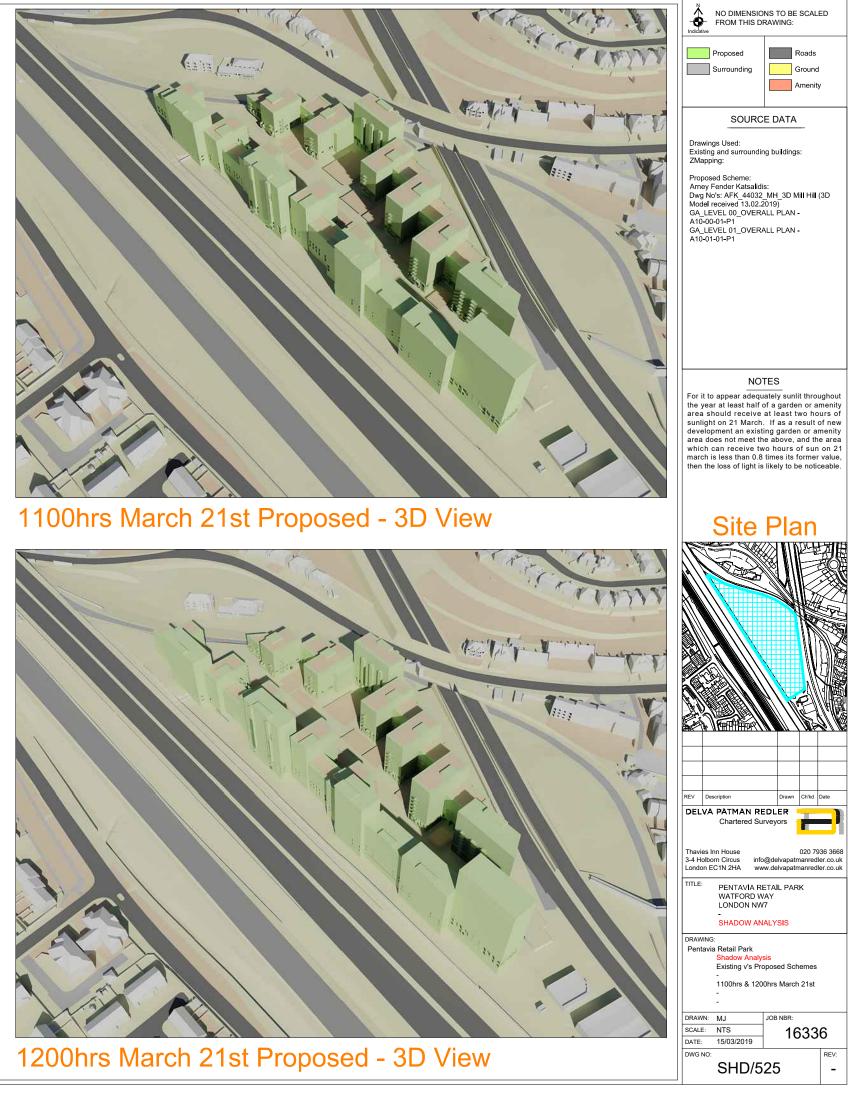

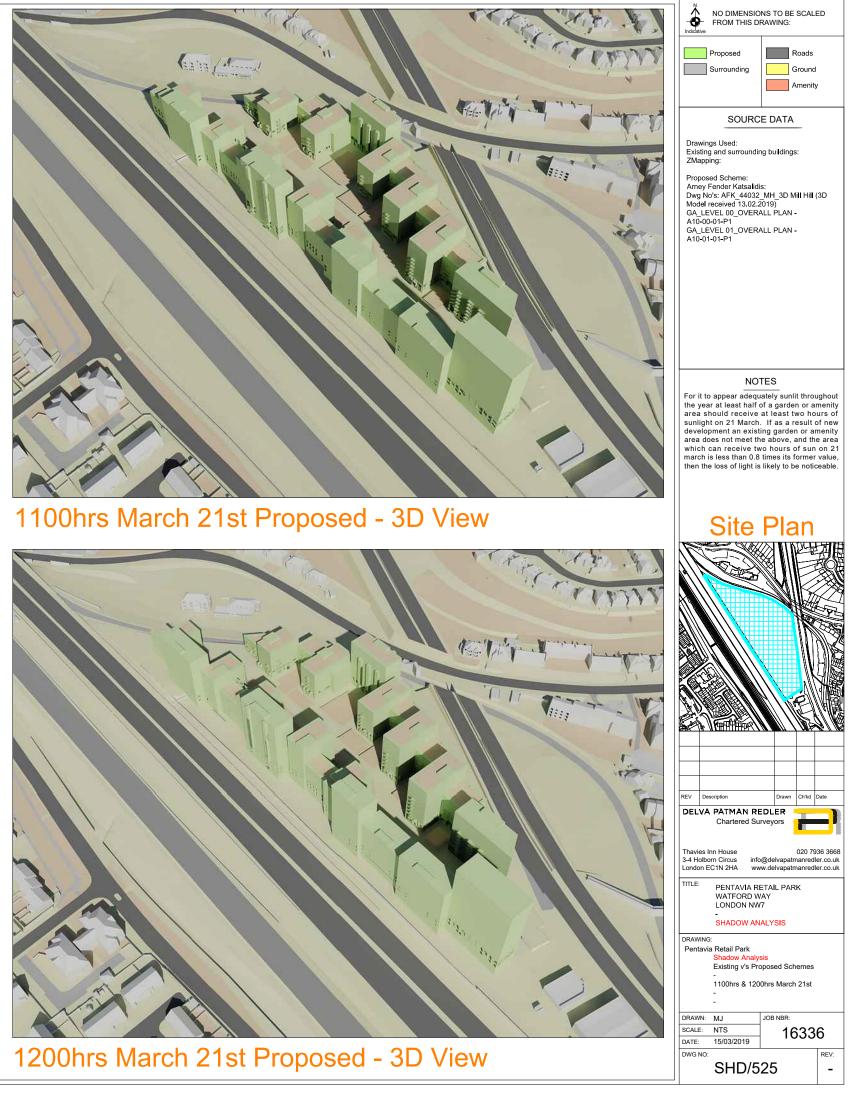


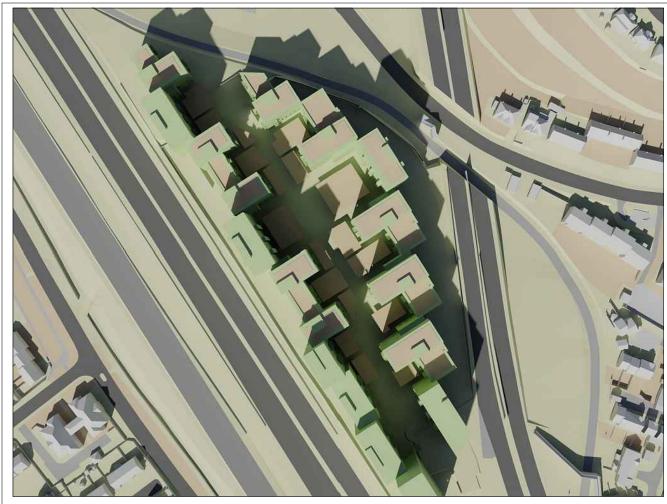



1300hrs March 21st Proposed - Plan




1400hrs March 21st Proposed - Plan

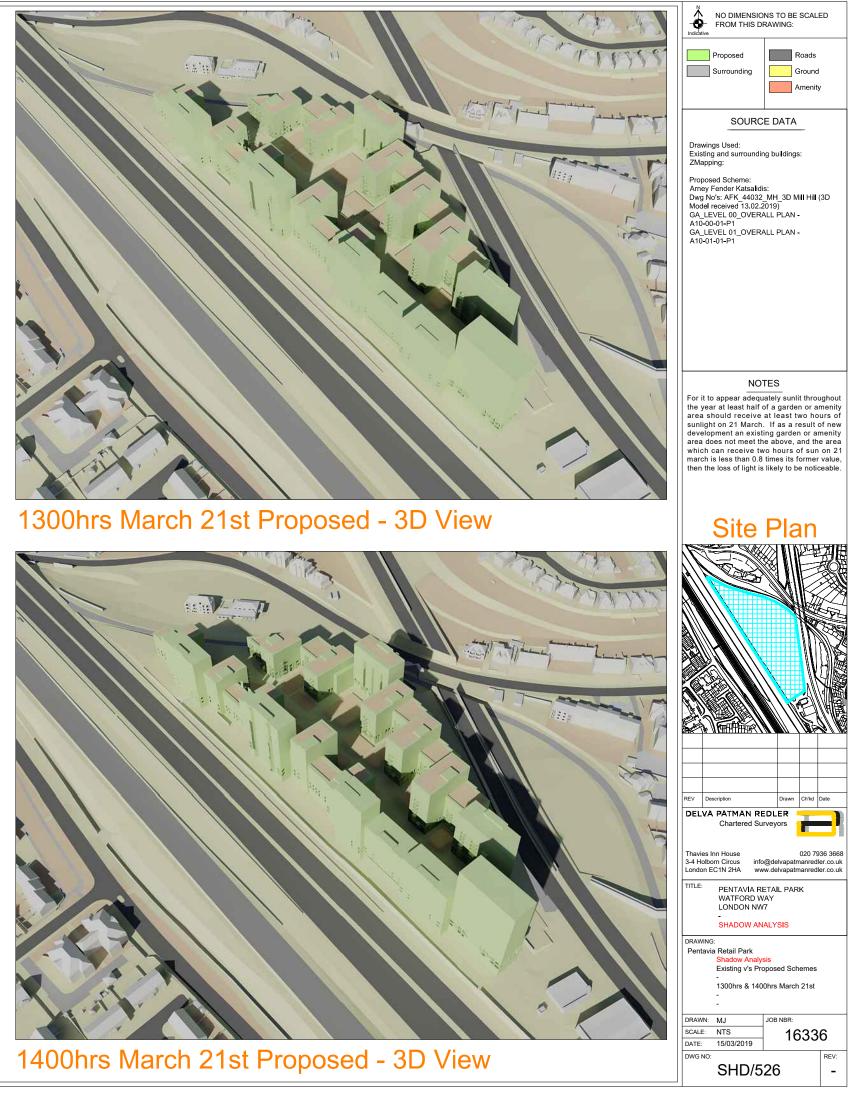

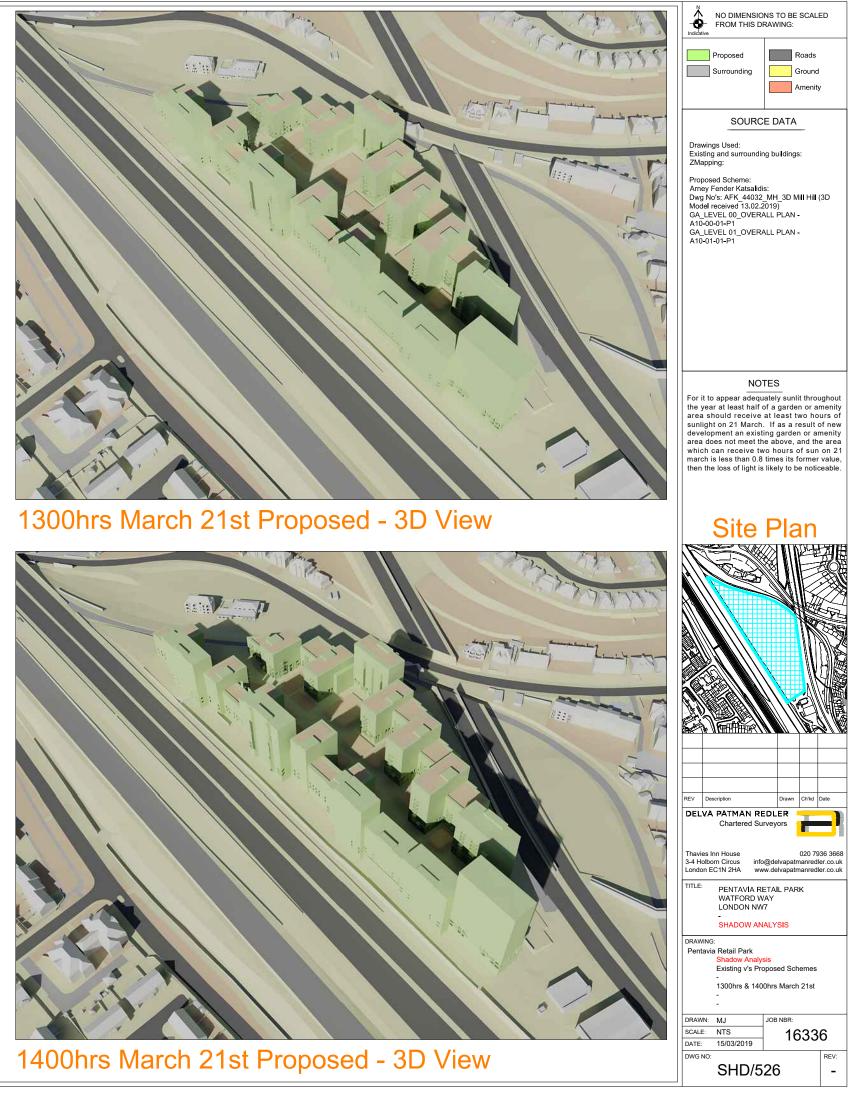


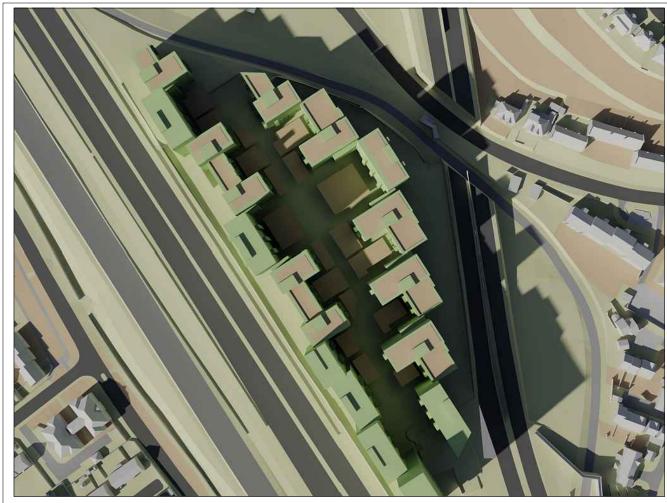



1500hrs March 21st Proposed - Plan

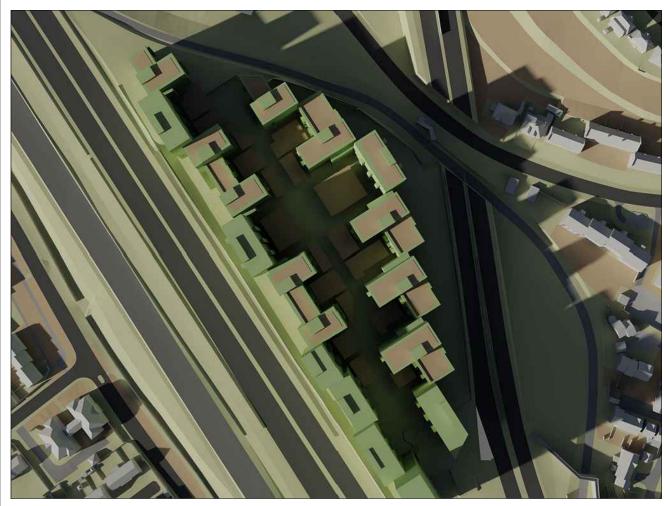

1600hrs March 21st Proposed - Plan

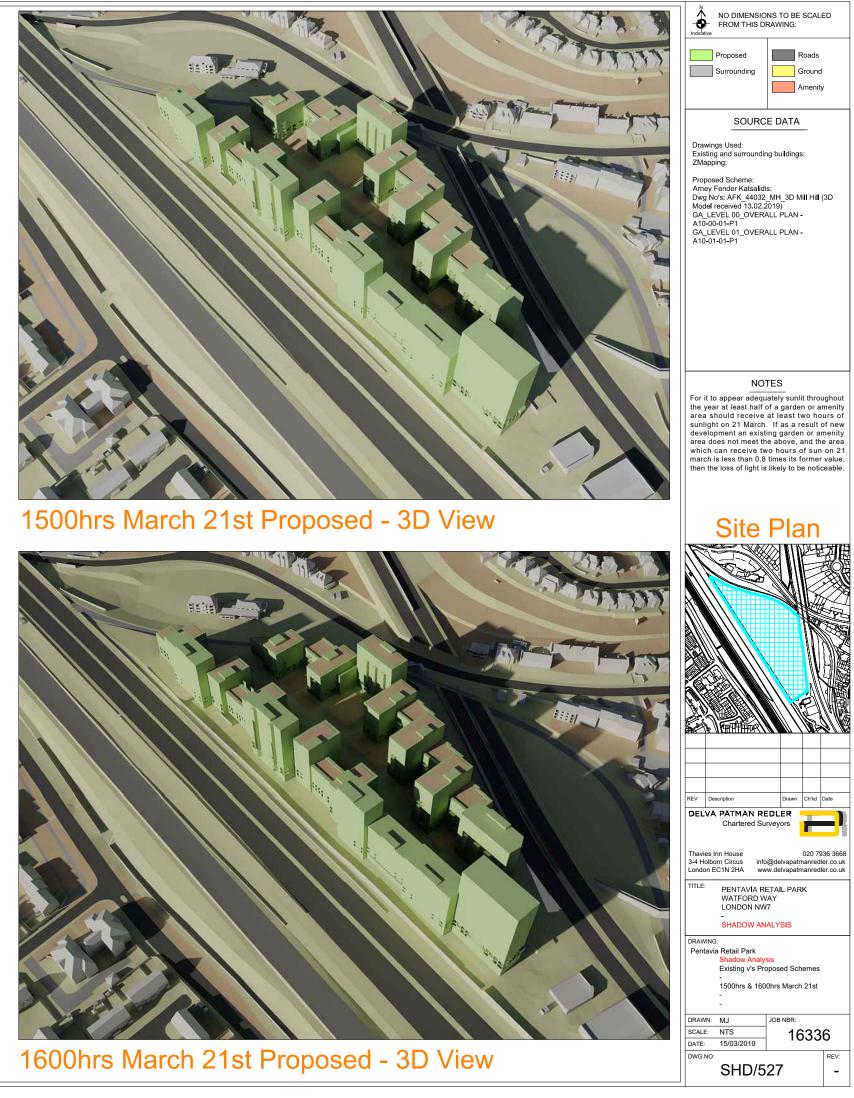

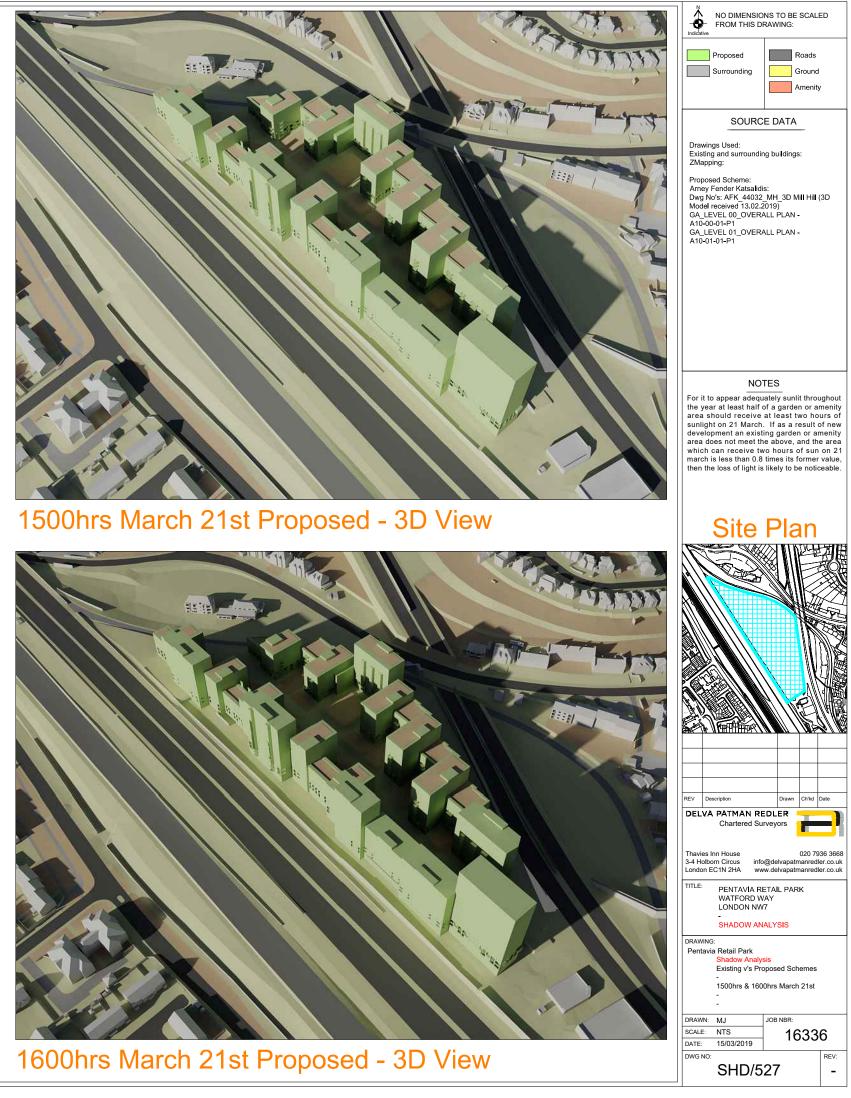

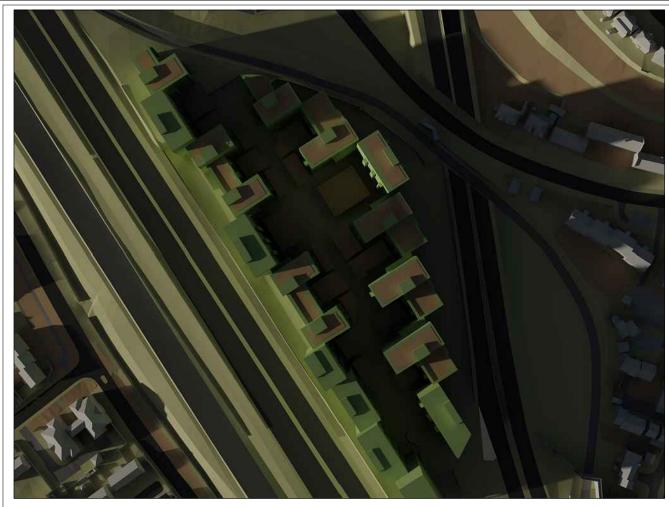

1700hrs March 21st Proposed - Plan



1700hrs March 21st Proposed - 3D View

Indicative	NO DIMENSIO FROM THIS D		SCALI	ED
	Proposed Surrounding		Roads Ground Amenity	,
	SOURC	E DATA		
Existing ZMappi Propose	is Used: and surroundir ng: ed Scheme: ender Katsalidi		s:	
Dwg No Model n GA_LE A10-00	's: AFK_44032 eceived 13.02.2 /EL 00_OVER/ 01-P1 /EL 01_OVER/	_MH_3D N 2019) ALL PLAN	-	(3D
For it to	NO appear adequ	TES ately sun	it throu	uahout
the year area sh sunlight develop area do which c	r at least half ould receive on 21 March ment an exist es not meet th an receive tw s less than 0.8	of a garde at least t If as a r ing garde e above, vo hours	en or an wo ho result o n or ar and the of sun	menity urs of of new menity e area on 21
\square				
	cription PATMAN RE Chartered Su		Ch'kd	Date
Thavies In 3-4 Holbor London E	m Circus info C1N 2HA ww	@delvapati w.delvapati	manredl manredl	
	PENTAVIA RI WATFORD W LONDON NW	AY 7	NR.	
DRAWING: Pentavia		sis	nemes	
	1700hrs March			
DRAWN: SCALE:	MJ NTS	JOB NBR:	533	6
DATE:	15/03/2019	10	500	_
DWG NO:	SHD/5	28		REV:



Proposed Shadow Contour

Amenity Area (m ²)		BRE Recommendations (At least 50% of Amenity Area)	Proposed Area	Proposed %age of Area
Mill Hill\Ground\A1	270.82	135.41	245.29	91%
Mill Hill\Ground\A2	160.96	80.48	160.96	100%
Mill Hill\Ground\A3	496.50	248.25	379.98	77%
Mill Hill\Ground\A4	209.55	104.77	209.55	100%
Mill Hill\Ground\A5	265.89	132.95	112.26	42%
Mill Hill\Ground\A6	197.88	98.94	0.00	0%
Mill Hill\Ground\A7	131.67	65.84	0.00	0%
Mill Hill\Ground\A8	155.56	77.78	0.00	0%
Mill Hill\Ground\A9	134.40	67.20	1.60	1%
Mill Hill\Ground\A10	105.49	52.75	31.18	30%
Mill Hill\Ground\A11	235.22	117.61	0.00	0%
Mill Hill\Ground\A12	115.30	57.65	47.02	41%
Mill Hill\Ground\A13	377.56	188.78	0.00	0%
Mill Hill\Ground\A14	108.12	54.06	108.06	100%
Mill Hill\Ground\A16	99.07	49.54	97.71	99%
Mill Hill\Ground\A15	205.62	102.81	88.41	43%
Mill Hill\Ground\A17	143.97	71.98	3.11	2%
Mill Hill\Ground\A18	222.62	111.31	6.66	3%
Block P\Roof\A1	130.16	65.08	64.72	50%
Block P\Roof\A2	178.63	89.31	178.39	100%
Block M\Roof\A1	266.69	133.35	231.20	87%
Block M\Roof\A2	271.27	135.64	268.49	99%
Block K\Roof\A1	235.15	117.57	234.64	100%
Block H\Roof\A1	272.24	136.12	269.14	99%
Block H\Roof\A2	227.12	113.56	212.82	94%
Block F\Roof\A1	271.99	135.99	269.94	99%
Block F\Roof\A2	227.12	113.56	211.75	93%
Block D\Roof\A1	272.22	136.11	270.08	99%
Block D\Roof\A2	227.12	113.56	213.60	94%
Block I\Roof\A1	150.31	75.15	150.23	100%
Block J\Roof\A2	163.17	81.58	137.36	84%
Block J\Roof\A1	158.00	79.00	155.64	99%
Block N\Roof\A1	163.00	81.50	163.00	100%
Block O\Roof\A2	163.17	81.58	136.83	84%
Block O\Roof\A1	148.97	74.48	146.34	98%
Block R\Roof\A2	164.00	82.00	164.00	100%
Block R\Roof\A1	91.68	45.84	86.02	94%
Total	7418.18	3709.09	5055.99	68%

NO DIMENSIONS TO BE SU	CALE	ED					
	ads bund ienity	,					
SOURCE DATA	SOURCE DATA						
Drawings Used: Existing and surrounding buildings: ZMapping:							
Proposed Scheme: Arney Fender Katsalidis: Dwg No's: AFK_44032_MH_3D Mill Model received 13.02.2019) GA_LEVEL 00_OVERALL PLAN - A10-00-01-P1 GA_LEVEL 01_OVERALL PLAN - A10-01-01-P1	Hill (3D					
NOTES For it to appear adequately sunlit the year at least half of a garden area should receive at least two sunlight on 21 March. If as a res development an existing garden of area does not meet the above, an which can receive two hours of march is less than 0.8 times its for then the loss of light is likely to be	oran o ho sult c or ar d the sun mer	menity urs of of new nenity e area on 21 value,					
Site Pla							
REV Description Drawn C DELVA PATMAN REDLER Chartered Surveyors Image: Chartered Surveyors	h'kd I						
Thavies Inn House 02 3-4 Holborn Circus info@delvapatma London EC1N 2HA www.delvapatma	nredl						
TITLE: PENTAVIA RETAIL PARK WATFORD WAY LONDON NW7 - SHADOW ANALYSIS							
DRAWING:							
Pentavia Retail Park Shadow Analysis Existing v's Proposed Schemes - Permanent Shadow Areas							
DRAWN: MJ JOB NBR: SCALE: NTS 163	33	6					
SHD/529		REV:					